



LAC

September 12, 2022

Anne Maurer

M.S. Groundwater Engineer New Mexico Environment Department Ground Water Quality Bureau 1190 St. Francis Dr. Santa Fe, NM 87502

Carmen Rose

Sr. Reclamation Specialist Mining and Minerals Division Mining Act Reclamation Program 1220 S. St. Francis Drive Santa Fe, NM 87505

RE: Response to Joint Agency Request for Additional Information, Waste Rock Pile Workplan Design Package and 2021 Cover Performance Review, Cunningham Hill Mine Reclamation Project, MMD Permit No. SF002RE and NMED DP-55

Dear Ms. Maurer and Ms. Rose,

After the August 26, 2022 Waste Rock Pile Improvement Drawings Revision 01 submittal the design engineer identified an error in slopes shown on bench 3 profile B. The error has been corrected; therefore, LAC Minerals (USA) LLC hereby provides the attached Waste Rock Pile Improvement Drawings Revision 02 prepared by Daniel B. Stephens & Associates, Inc.

If you have questions or comments, please contact me at (775) 397-7215 or dlattin@barrick.com.

Sincerely,


Daniel Lattin, P.E.

Sr. Closure Program Manager


ec:

Holland Shepherd

Brad Bingham Adam Arguello Patrick Malone Steven Finch Jeffrey Samson

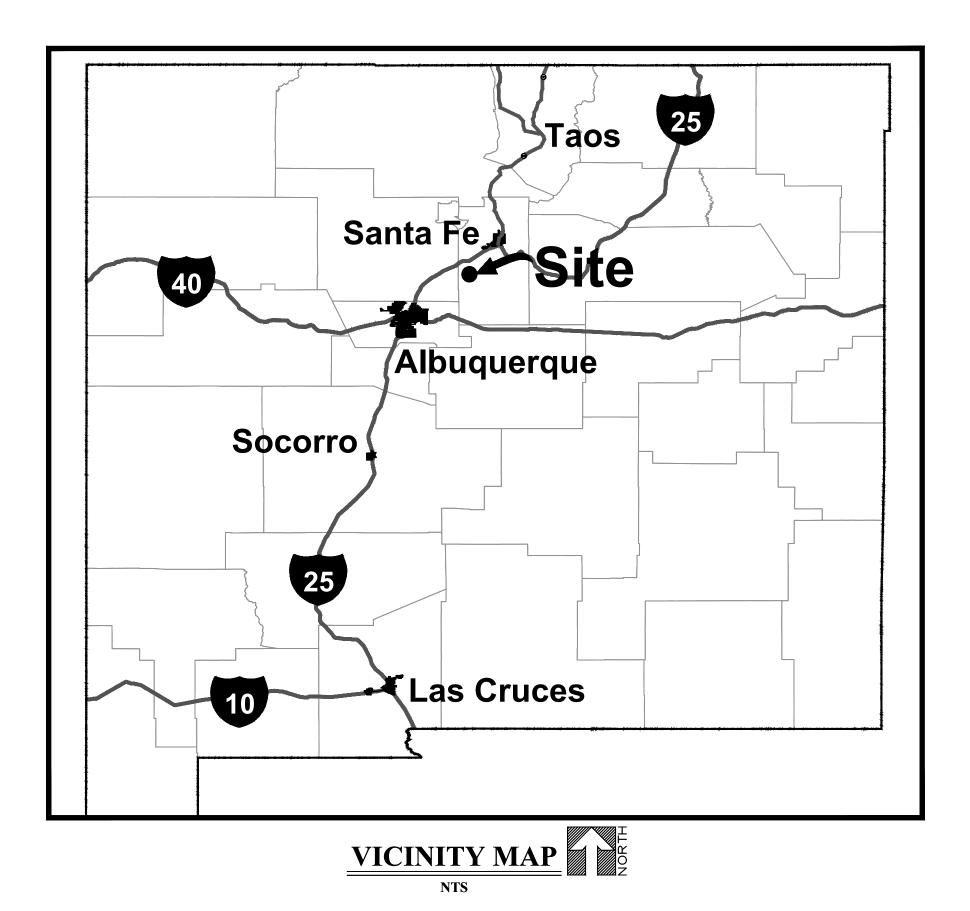



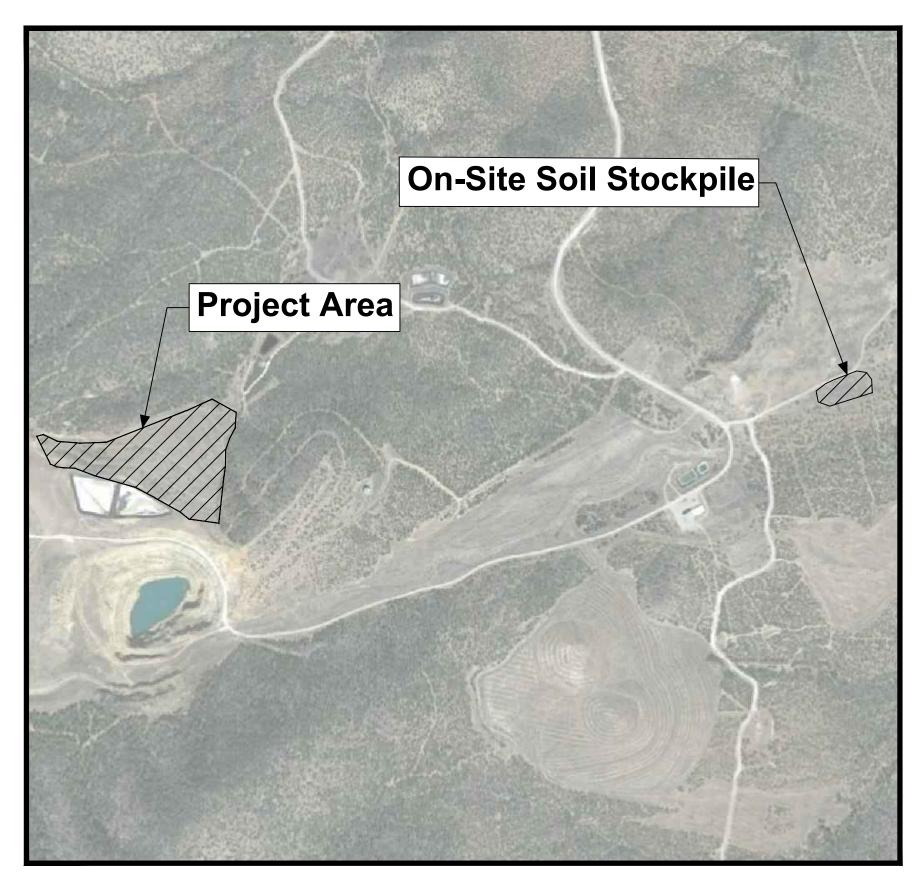



CUNNINGHAM HILL WASTE ROCK PILE IMPROVEMENTS

PREPARED FOR LAC MINERALS (USA) LLC

INI	DEX	OF DRAWINGS	REVISION
		<u>GENERAL</u>	
1	G-0	COVER SHEET AND INDEX	0
2	G-1	GENERAL NOTES AND LEGEND	0
		CIVIL	
3	C-1	SITE PLAN	0
4	C-2	BENCH PROFILES AND SECTIONS I	0
5	C-3	BENCH PROFILES AND SECTIONS II	0
6	C-4	BENCH PROFILES AND SECTIONS III	0
7	C-5	BENCH PROFILES AND SECTIONS IV	0
8	C-6	CIVIL DETAILS	0

108	REV. NO.	DATE	DESCRIPTION	APPROVED BY	DATE OF ISSUE: 08/24/2022	
B22.	0	05/19/2022	ISSUED FOR CONSTRUCTION	JES	DATE OF 1330E	
S\DE	1	08/24/2022	ISSUED FOR CONSTRUCTION	JES	DESIGNED BY:JS	
ECTS	2	09/09/2022	ISSUED FOR CONSTRUCTION	JES	DRAWN BY: JA	
PROJ					CHECKED BY: GP/JPA	
\s'					CHECKED BIGF/JFA	
1					APPROVED BY:JS	





CUNNINGHAM HILL SANTA FE COUNTY, NEW MEXICO CUNNINGHAM HILL WASTE ROCK PILE IMPROVEMENTS SANTA FE COUNTY, NM

COVER SHEET AND INDEX

SHEET 1 OF 8 DWG NO. G-0

- B. THE CONTRACTOR IS RESPONSIBLE FOR OBTAINING ALL REQUIRED CONSTRUCTION PERMITS AND APPROVALS OF LIKE KIND PRIOR TO START OF CONSTRUCTION.
- C. PROJECT DOCUMENTS CONSIST OF THESE DRAWINGS, PROJECT CONTRACTS, AND ANY AND ALL SUBSEQUENT EXECUTED PROJECT DOCUMENTATION ISSUED AS, OR WITH, CHANGE ORDERS, AND RFI'S (REQUEST FOR INFORMATION.) THE CONTRACTOR SHALL REVIEW ALL PROJECT DOCUMENTS AND VERIFY ALL DIMENSIONS, QUANTITIES, AND FIELD CONDITIONS. ANY CONFLICTS OR OMISSIONS WITH THE DOCUMENTS SHALL BE REPORTED TO THE ENGINEER/PROJECT MANAGER FOR CLARIFICATION PRIOR TO PERFORMANCE OF ANY WORK IN QUESTION. IN THE EVENT THE CONTRACTOR DOES NOT NOTIFY THE ENGINEER/PROJECT MANAGER, THE CONTRACTOR ASSUMES FULL RESPONSIBILITY AND ANY AND ALL EXPENSE FOR ANY REVISIONS NECESSARY OR CORRECTIONAL WORK REQUIRED.
- D. THERE ARE NO BURIED UTILITIES WITHIN THE PROJECT BOUNDARY BASED UPON INFORMATION PROVIDED TO THE ENGINEER BY OTHERS. IF EXISTING BURIED UTILITIES ARE ENCOUNTERED, THE CONTRACTOR SHALL NOTIFY THE OWNER AND ENGINEER.
- E. EXISTING FENCING THAT IS NOT DESIGNATED FOR REMOVAL SHALL NOT BE DISTURBED. ANY FENCING THAT IS DISTURBED OR ALTERED BY THE CONTRACTOR SHALL BE RESTORED TO ITS ORIGINAL CONDITION AT THE CONTRACTOR'S EXPENSE. IF THE CONTRACTOR DESIRES TO REMOVE FENCING TO ACCOMMODATE CONSTRUCTION ACTIVITIES, THE CONTRACTOR SHALL OBTAIN THE OWNER'S WRITTEN PERMISSION BEFORE FENCE IS REMOVED. CONTRACTOR SHALL RESTORE THE FENCE TO ITS ORIGINAL CONDITION AT THE EARLIEST OPPORTUNITY TO THE SATISFACTION OF THE OWNER. WHILE ANY FENCING IS REMOVED, THE CONTRACTOR SHALL BE SOLELY RESPONSIBLE FOR SECURITY OF THE SITE UNTIL THE FENCE IS RESTORED.
- F. AT THE END OF EACH WORK DAY, THE CONTRACTOR SHALL CLEAN AND PICK UP THE WORK AREA TO THE SATISFACTION OF THE ENGINEER/PROJECT MANAGER. AT NO TIME SHALL THE WORK BE LEFT IN A MANNER THAT COULD ENDANGER THE WORKERS OR THE PUBLIC.
- G. ALL MATERIALS AND WORKMANSHIP SHALL CONFORM TO PROJECT PLANS, AS AMENDED AND REVISED BY THE ENGINEER. ALL INSTALLATION DETAILS ARE TYPICAL AND MAY BE CHANGED TO BETTER FIT EXISTING LOCAL CONDITIONS UPON APPROVAL BY THE ENGINEER.
- H. ONLY THE CONTRACTOR SHALL BE RESPONSIBLE FOR SAFETY OF ALL WORK. ALL WORK, INCLUDING WORK WITHIN TRENCHES, SHALL BE IN ACCORDANCE WITH THE OCCUPATIONAL SAFETY AND HEALTH ACT (OSHA)
- REFERENCES MADE TO STANDARD SPECIFICATIONS AND STANDARD DRAWINGS REFER TO THE NEW MEXICO CHAPTER OF THE AMERICAN PUBLIC WORKS ASSOCIATION (NM-APWA) STANDARDS FOR PUBLIC WORKS CONSTRUCTION.
- J. THE CONTRACTOR SHALL NOT INSTALL ITEMS AS SHOWN ON THESE PLANS WHEN IT IS OBVIOUS THAT FIELD CONDITIONS ARE DIFFERENT THAN SHOWN IN THE PLANS. SUCH CONDITIONS SHALL BE BROUGHT TO THE ATTENTION OF THE ENGINEER IN A TIMELY MANNER. IN THE EVENT THE CONTRACTOR DOES NOT NOTIFY THE ENGINEER IN A TIMELY MANNER, THE CONTRACTOR ASSUMES FULL RESPONSIBILITY AND EXPENSE FOR ANY REVISIONS NECESSARY, INCLUDING ENGINEERING DESIGN FEES.
- K. EXISTING SITE IMPROVEMENTS WHICH ARE DAMAGED OR DISPLACED BY THE CONTRACTOR SHALL BE REMOVED AND REPLACED BY THE CONTRACTOR AT THE CONTRACTOR'S EXPENSE. REPAIRS SHALL BE APPROVED BY THE OWNER PRIOR TO CONSTRUCTION OF THE REPAIRS. REPAIRS SHALL BE ACCEPTED BY THE OWNER PRIOR TO FINAL PAYMENT.
- L. CONTRACTOR TO COMPLETE PROCTORS ON NATIVE MATERIAL, AS DIRECTED BY THESE

SURVEY MONUMENTS. PROPERTY CORNERS, BENCHMARKS

- M. THE CONTRACTOR SHALL NOTIFY THE OWNER AT LEAST SEVEN (7) DAYS BEFORE BEGINNING ANY CONSTRUCTION ACTIVITY THAT COULD DAMAGE OR DISPLACE SURVEY MONUMENTS, PROPERTY CORNERS, OR PROJECT BENCHMARKS SO THESE ITEMS MAY BE RELOCATED.
- N. ANY SURVEY MONUMENTS, PROPERTY CORNERS, OR BENCHMARKS THAT ARE NOT IDENTIFIED FOR RELOCATION ARE THE RESPONSIBILITY OF THE CONTRACTOR TO PRESERVE AND PROTECT, RELOCATION OR REPLACEMENT OF THESE ITEMS SHALL BE DONE BY THE OWNER'S SURVEYOR AT THE EXPENSE OF THE CONTRACTOR.

DESIGN SURVEY

- O. SURVEY PROJECT CONTROL WAS REFERRED TO THE NEW MEXICO STATE PLANE COORDINATE SYSTEM (NAD 27-CENTRAL ZONE) AND NGVD 29 VERTICAL DATUM.
- P. THIS DESIGN IS BASED ON SURVEY INFORMATION PROVIDED BY OTHERS. THE ENGINEER CANNOT VALIDATE OR WARRANTY THIS INFORMATION. ANY DISCREPANCIES BETWEEN THE DESIGN AND SITE SURFACE CONDITIONS SHALL BE BROUGHT TO THE ENGINEER'S ATTENTION IMMEDIATELY.

CONSTRUCTION LIMITS

- Q. SHALL BE AS SHOWN ON PLANS.
- R. THE CONTRACTOR SHALL MAINTAIN A RECORD DRAWING SET OF PLANS AND PROMPTLY

LOCATE ALL UTILITIES, EXISTING OR NEW, IN THEIR CORRECT LOCATION, HORIZONTAL AND VERTICAL. THIS RECORD SET OF DRAWINGS SHALL BE MAINTAINED ON THE PROJECT SITE AND SHALL BE AVAILABLE TO THE OWNER AND ENGINEER AT ANY TIME DURING CONSTRUCTION. RECORD INFORMATION SHALL INCLUDE HORIZONTAL AND VERTICAL COORDINATE CALLOUTS, LINE SIZES, LINE TYPES, BURIAL DEPTHS, AND ALL OTHER PERTINENT INSTALLATION INFORMATION. IN ADDITION ALL ITEMS THAT ARE INSTALLED EXACTLY AS DESIGNED SHALL BE NOTED AS SUCH.

EROSION CONTROL, ENVIRONMENTAL PROTECTION, AND STORM WATER POLLUTION PREVENTION PLAN

- S. THE CONTRACTOR SHALL CONFORM TO ALL SANTA FE COUNTY, STATE OF NEW MEXICO. AND FEDERAL DUST AND EROSION CONTROL REGULATIONS. THE CONTRACTOR SHALL PREPARE AND OBTAIN ANY DUST CONTROL OR EROSION CONTROL PERMITS FROM THE APPROPRIATE REGULATORY AGENCIES.
- T. THE CONTRACTOR SHALL ENSURE THAT NO SOIL ERODES FROM THE SITE ONTO ADJACENT PROPERTY BY CONSTRUCTION OF TEMPORARY EROSION CONTROL BERMS OR INSTALLING SILT FENCES AT THE PROPERTY LINES (OR LIMITS OF CONSTRUCTION WHERE DESIGNATED) AND WETTING SOIL TO PREVENT IT FROM BLOWING.
- U. WATERING, AS REQUIRED FOR CONSTRUCTION DUST CONTROL, SHALL BE CONSIDERED INCIDENTAL TO CONSTRUCTION AND NO MEASUREMENT OR PAYMENT SHALL BE MADE. CONSTRUCTION AREAS SHALL BE WATERED FOR DUST CONTROL IN COMPLIANCE WITH COUNTY AND STATE ORDINANCES. THE CONTRACTOR SHALL BE RESPONSIBLE FOR COORDINATING WITH THE OWNER, FOR AVAILABILITY AND USE OF WATER. THE CONTRACTOR SHALL BE RESPONSIBLE FOR SUPPLYING ALL EQUIPMENT AND MATERIALS NECESSARY FOR TRANSPORTATION AND USE OF WATER.
- V. ALL WASTE PRODUCTS FROM THE CONSTRUCTION SITE, INCLUDING ITEMS DESIGNED FOR REMOVAL, CONSTRUCTION WASTE, CONSTRUCTION EQUIPMENT WASTE PRODUCTS (OIL, GAS, TIRES, ETC.), GARBAGE, GRUBBING, EXCESS CUT MATERIAL, VEGETATIVE DEBRIS, ETC. SHALL BE APPROPRIATELY DISPOSED OF OFFSITE UNLESS OTHERWISE DIRECTED BY THE ENGINEER/PROJECT MANAGER AT NO ADDITIONAL COST TO THE OWNER. IT SHALL BE THE CONTRACTOR'S RESPONSIBILITY TO OBTAIN ANY PERMITS REQUIRED FOR HAUL OR DISPOSAL OF WASTE PRODUCTS. IT SHALL BE THE CONTRACTOR'S RESPONSIBILITY TO ENSURE THAT THE WASTE DISPOSAL SITE COMPLIES WITH APPROPRIATE REGULATIONS REGARDING THE ENVIRONMENT, ENDANGERED SPECIES, AND ARCHAEOLOGICAL RESOURCES.
- W. THE CONTRACTOR SHALL REPORT AND CLEAN UP HAZARDOUS MATERIALS SPILLS IN ACCORDANCE WITH THE GOVERNING LAC MINERALS, INC. SPILL PREVENTION PLAN.
- X. THE CONTRACTOR SHALL COMPLY WITH ALL APPLICABLE REGULATIONS CONCERNING SURFACE AND UNDERGROUND WATER. CONTACT WITH SURFACE WATER BY CONSTRUCTION EQUIPMENT AND PERSONNEL SHALL BE MINIMIZED. EQUIPMENT MAINTENANCE AND REFUELING OPERATIONS SHALL BE PERFORMED IN AN ENVIRONMENTALLY SAFE MANNER IN COMPLIANCE WITH COUNTY, STATE, AND EPA REGULATIONS.
- Y. THE CONTRACTOR SHALL COMPLY WITH ALL APPLICABLE REGULATIONS CONCERNING CONSTRUCTION NOISE AND HOURS OF OPERATION AS IMPOSED BY THE OWNER OR COUNTY AUTHORITIES.

MISCELLANEOUS SYMBOLS:


NOTE: SYMBOLS ARE NOT SHOWN TO SCALE ON PLAN OR PROFILE DRAWINGS, AND INDICATE APPROXIMATE LOCATION ONLY.



EXISTING MAJOR CONTOUR LINE AND ELEVATION DESIGNATION



EXISTING MINOR CONTOUR LINE AND ELEVATION DESIGNATION

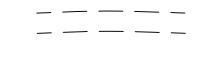


OR GRAVELED ROADWAY

SURVEY MONUMENT


(PREVIOUS PROJECT)

UNIMPROVED DIRT ROAD

EXISTING WIRE FENCE

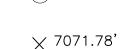

SPOT ELEVATION

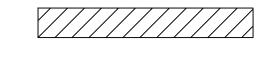


AREA REQUIRING CUT OR FILL



EXISTING UNDISTURBED SOIL

LEGEND:

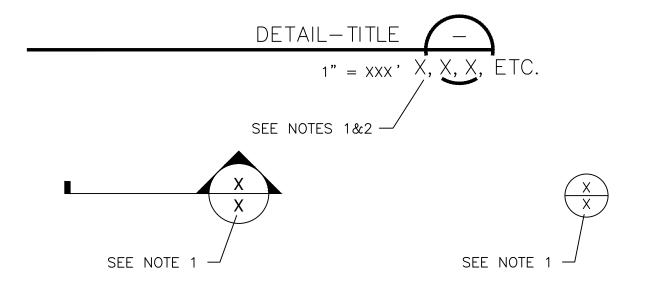


NOTES:

- 1. IF SECTION, DETAIL, SCHEMATIC, OR DIAGRAM IS DRAWN ON THE SAME SHEET THAT IT IS TAKEN FROM, THE SHEET NUMBER SHALL BE REPLACED WITH A HYPHEN.
- 2. IF THE SECTION, DETAIL, SCHEMATIC, OR DIAGRAM IS REFERENCED ON MULTIPLE SHEETS, ALL SHEETS SHOULD BE LÍSTED TO THE OUTSIDE RIGHT OF THE DETAIL— TITLE BUBBLE, AND SEPARATED WITH A COMMA.

ABBREVIATIONS:

	AMSL ASTM BGS DIA DR EW HDPE NV LB MIN NTS PSI SCH STA STD IP IPL IYP WL H V VPI	ABOVE MEAN SEA LEVEL AMERICAN SOCIETY FOR TESTING AND MATERIALS BENEATH GROUND SURFACE DIAMETER DIMENSION RATIO EACH WAY HIGH DENSITY POLYETHYLENE INVERT ELEVATION POUNDS MINIMUM NOT TO SCALE POUNDS PER SQUARE INCH SCHEDULE STANDARD DIMENSION RATIO STATION STANDARD TOP OF PIPE TEST PIT LOCATION TYPICAL WATER LINE HORIZONTAL VERTICAL VERTICAL
١	/PI	VERTICAL POINT OF INFLECTION

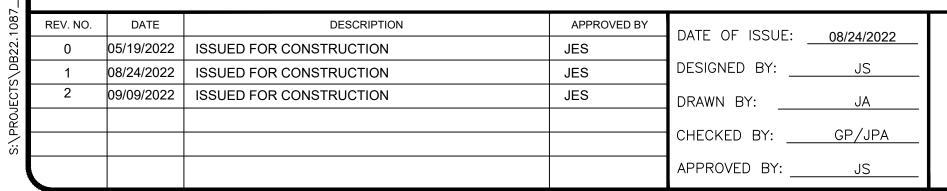





CUNNINGHAM HILL SANTA FE COUNTY, NEW MEXICO

CUNNINGHAM HILL WASTE ROCK PILE IMPROVEMENTS SANTA FE COUNTY, NM

GENERAL NOTES & LEGEND

ISHEET 2 OF 8 DWG NO. G-1



 05/19/2022
 ISSUED FOR CONSTRUCTION
 JES
 DATE OF ISSUE: 08/24/2022

 08/24/2022
 ISSUED FOR CONSTRUCTION
 JES
 DESIGNED BY: JS

 09/09/2022
 ISSUED FOR CONSTRUCTION
 JES
 DRAWN BY: JA

 CHECKED BY: GP/JPA
 APPROVED BY: JS







CUNNINGHAM HILL SANTA FE COUNTY, NEW MEXICO WASTE ROCK PILE IMPROVEMENTS
SANTA FE COUNTY, NM


SITE PLAN


SHEET 3 OF 8 DWG NO. C-1

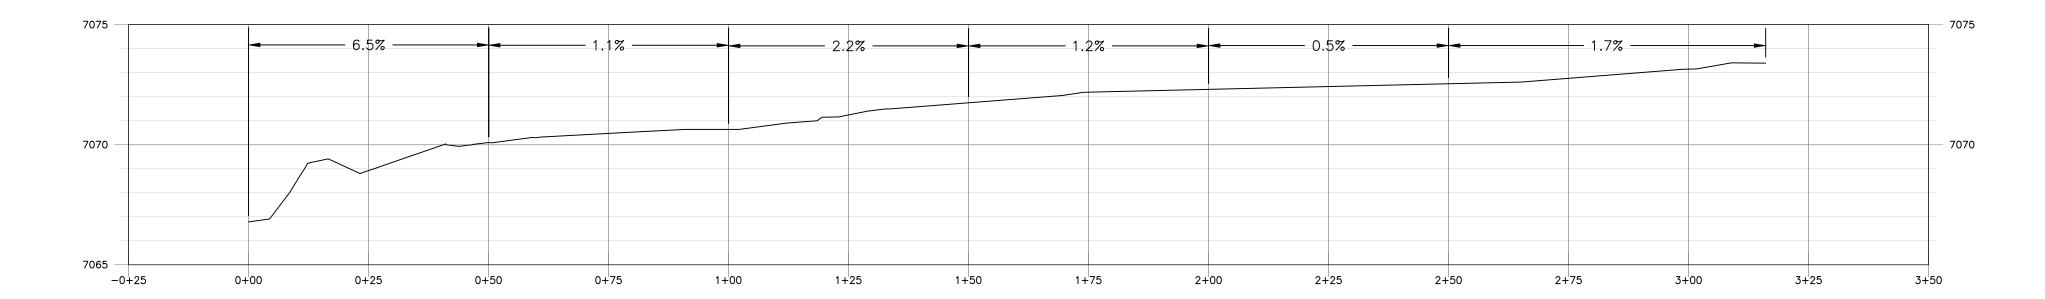




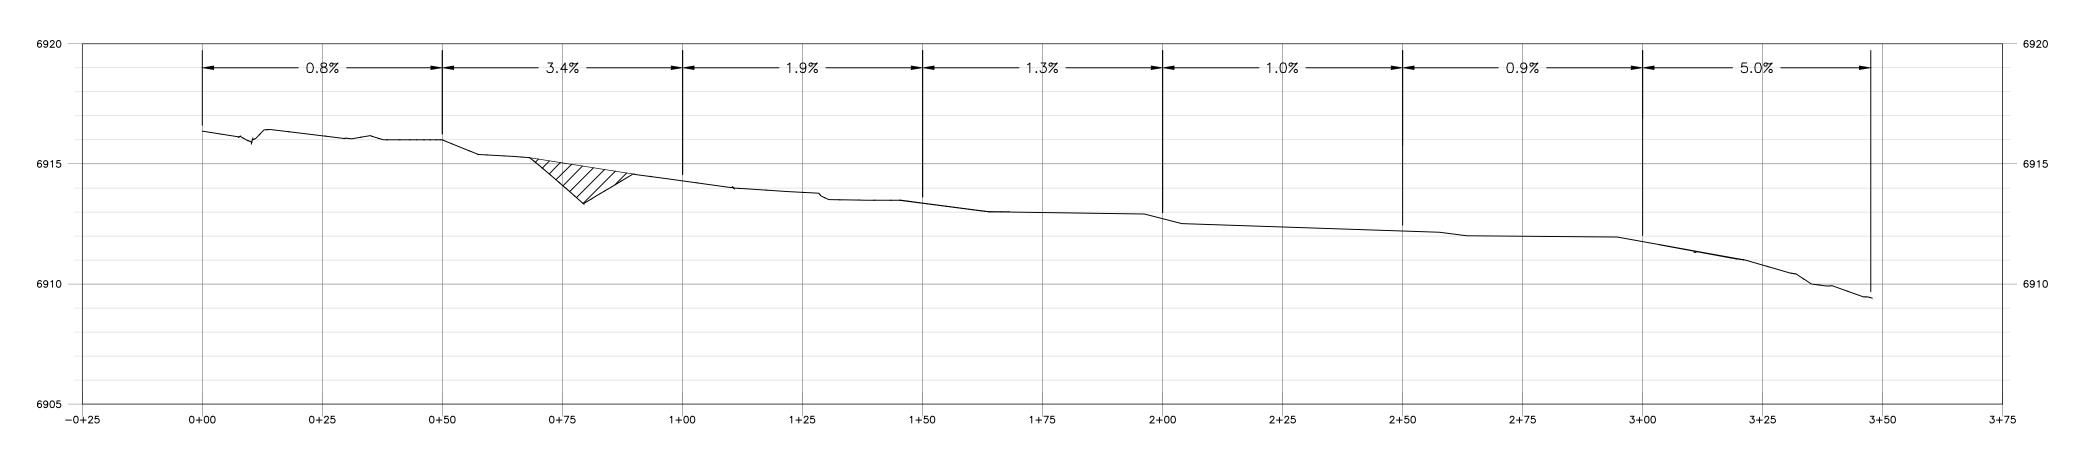


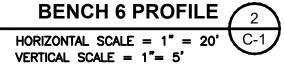

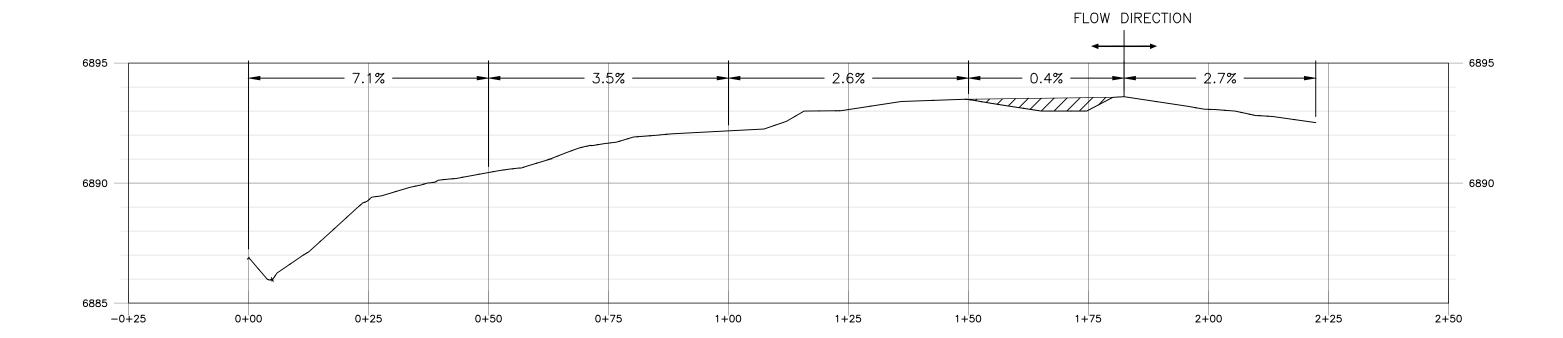

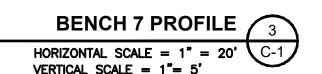

STA=0+68.14— TOP ELEV=6915.26'	STA= TOP	0+89.41 ELEV=6914.63'
6920		— 6920 —
6915		— 6915
6910		6910
6905 0+50	0+75 1+	IN PLACE: 9 CY LOOSE: 14 CY 00
HORIZONTAL SCAL VERTICAL SCALE :	SECTION (N-N') E = 1" = 20' C-1 = 1"= 5'	

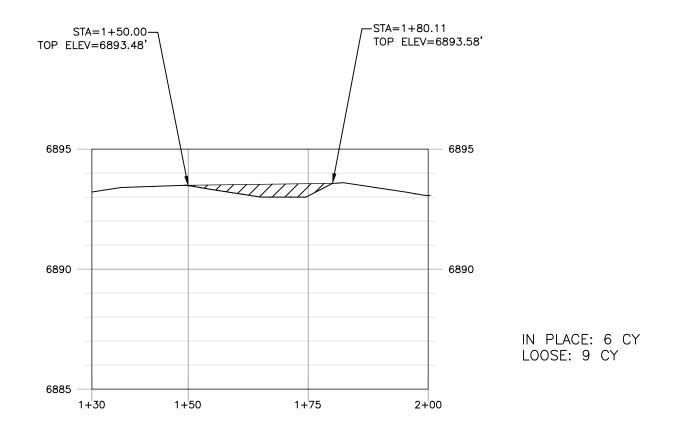

SECTION O-O'
HORIZONTAL SCALE = 1" = 20' C-1 VERTICAL SCALE = 1"= 5'

Ž∣	REV. NO.	DATE	DESCRIPTION	APPROVED BY	DATE OF ISSUE:	08/24/2022
222.	0	05/19/2022	ISSUED FOR CONSTRUCTION	JES	DATE OF 1330E.	00/24/2022
	1	08/24/2022	ISSUED FOR CONSTRUCTION	JES	DESIGNED BY:	JS
, ,	2	09/09/2022	ISSUED FOR CONSTRUCTION	JES	DRAWN BY:	JA
מ ע						
7					CHECKED BY:	GP/JPA
					APPROVED BY:	JS








CUNNINGHAM HILL SANTA FE COUNTY, NEW MEXICO CUNNINGHAM HILL WASTE ROCK PILE IMPROVEMENTS SANTA FE COUNTY, NM

BENCH PROFILES AND SECTIONS I


SHEET 4 OF 8 DWG NO. C-2

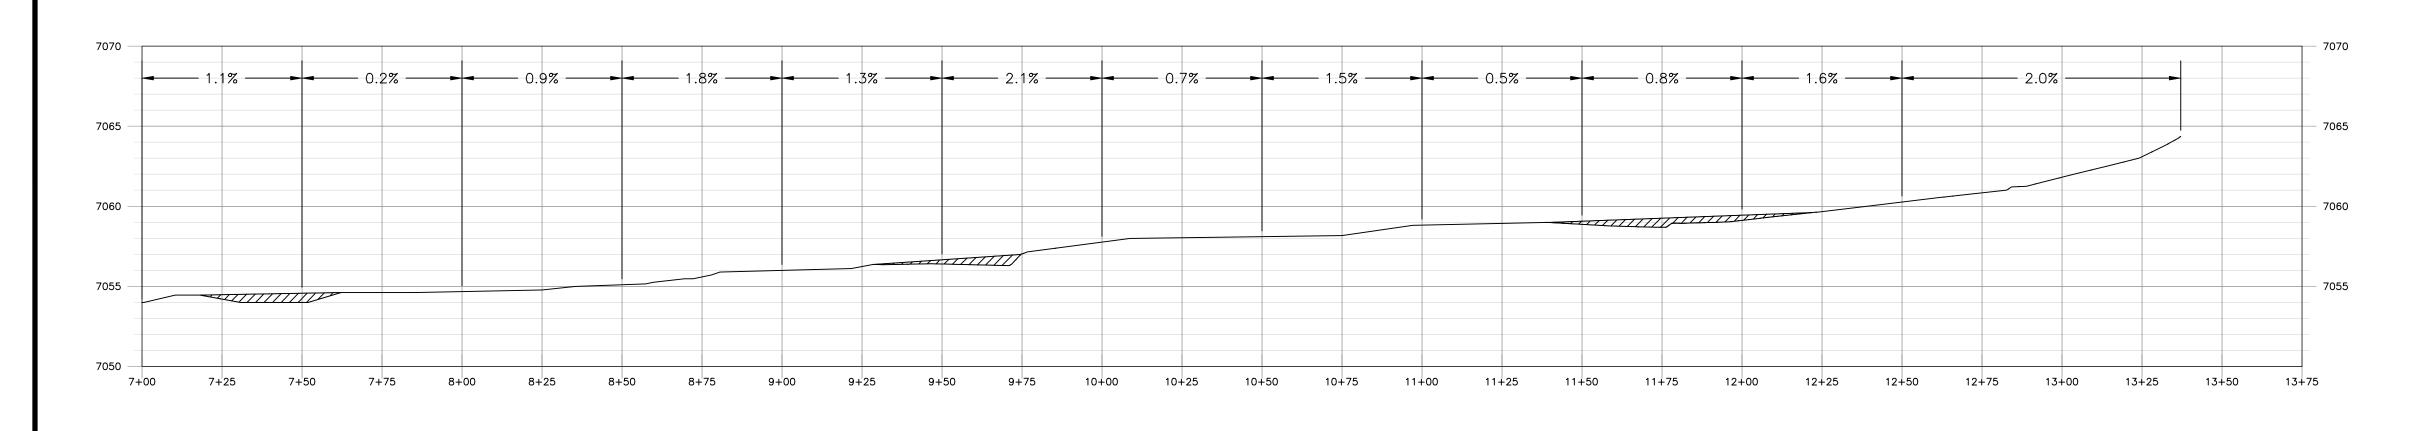


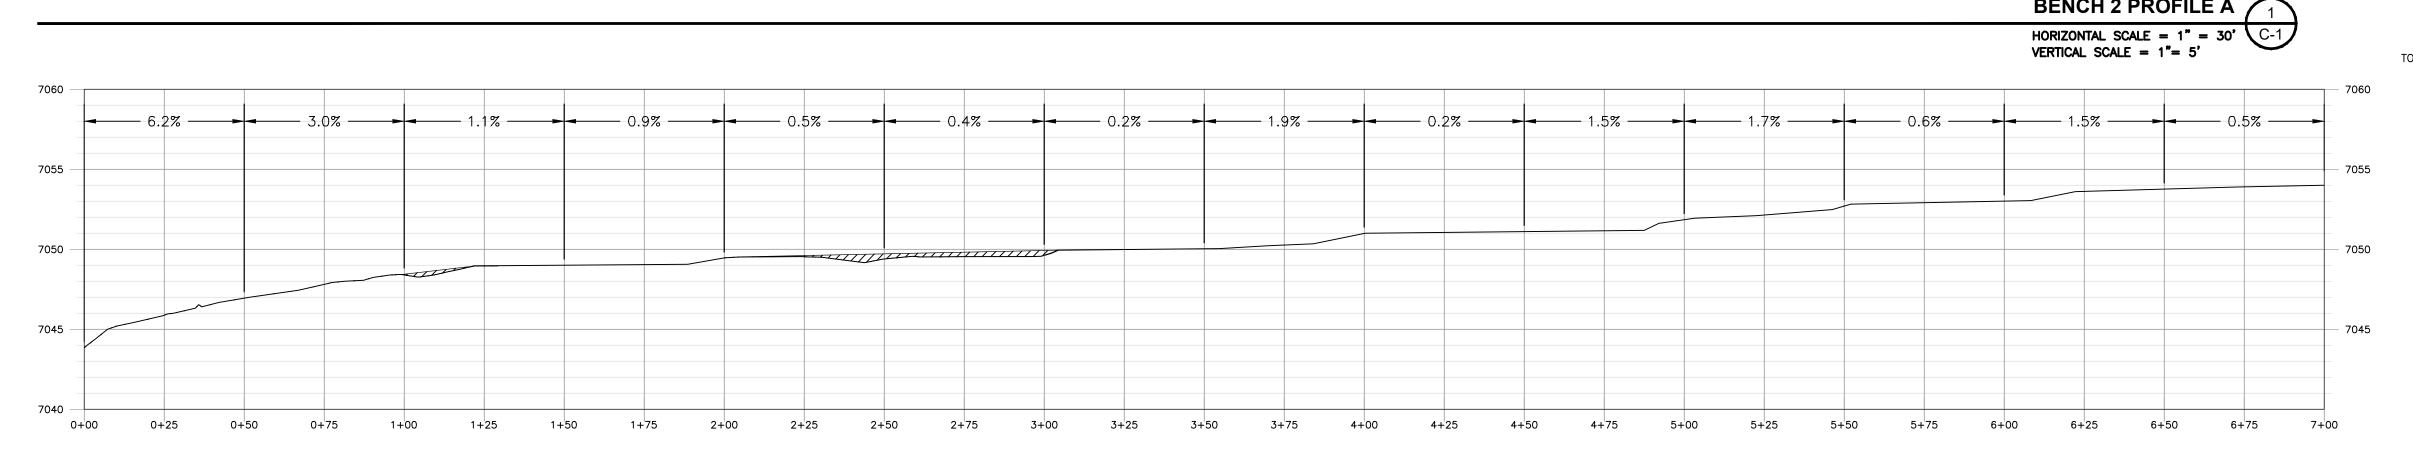


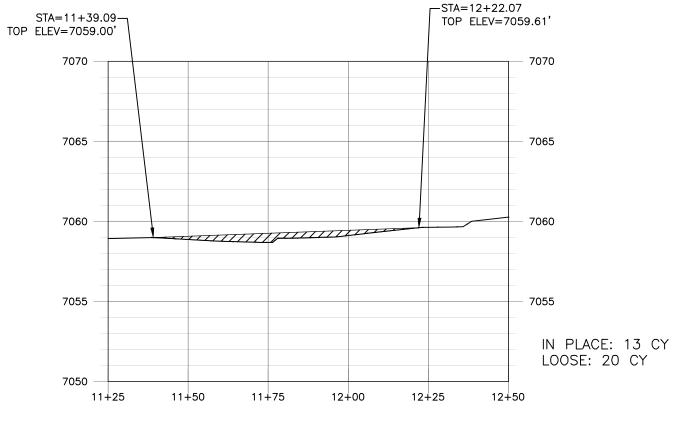



VERTICAL SCALE = 1"= 5"

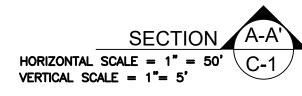

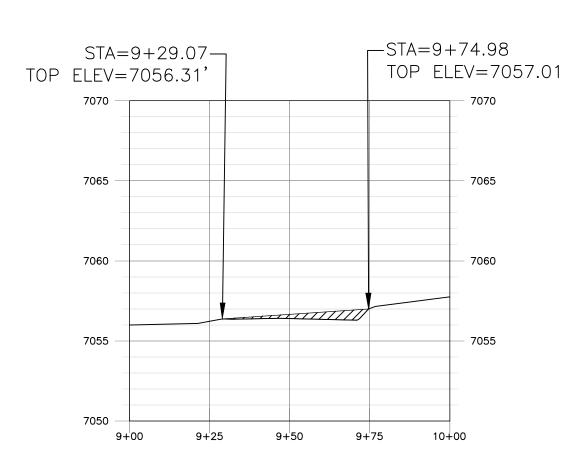

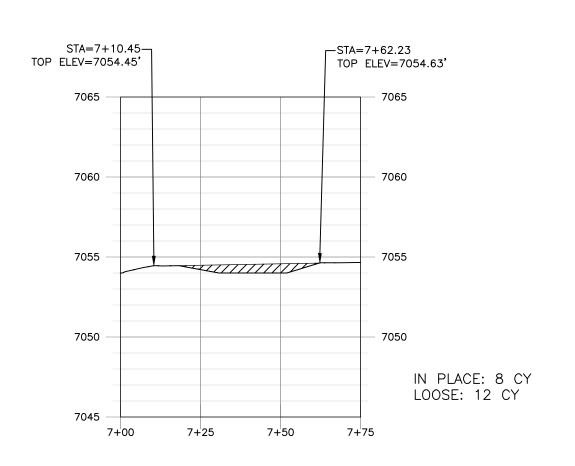

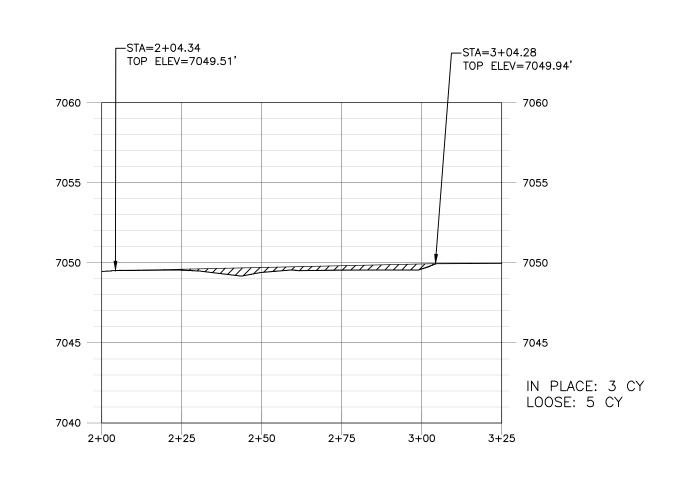

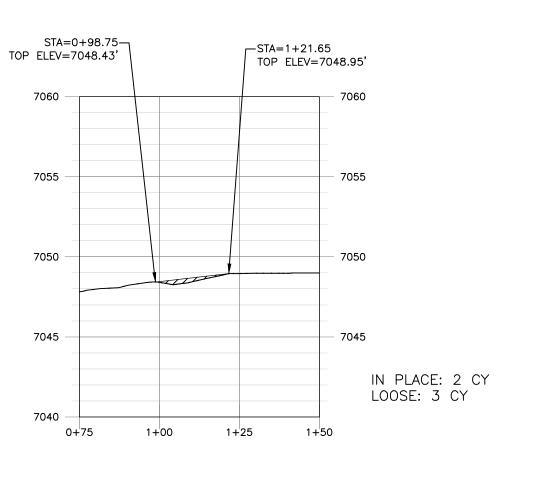

HORIZONTAL SCALE = 1" = 50' C-1
VERTICAL SCALE = 1"= 5'

HORIZONTAL SCALE = 1" = 50' C-1 VERTICAL SCALE = 1"= 5'

HORIZONTAL SCALE = 1" = 50' C-1 VERTICAL SCALE = 1" = 5'

SECTION	E-E'
HORIZONTAL SCALE = 1" = 50' VERTICAL SCALE = 1"= 5'	C 1

108,	REV. NO.	DATE	DESCRIPTION	APPROVED BY	DATE OF ISSUE: 08/24/2022
822.	0	05/19/2022	ISSUED FOR CONSTRUCTION	JES	DATE OF 1330E
S\DE	1	08/24/2022	ISSUED FOR CONSTRUCTION	JES	DESIGNED BY:JS
ECIS	2	09/09/2022	ISSUED FOR CONSTRUCTION	JES	DRAWN BY: JA
KO					
S:\F					CHECKED BY:GP/JPA
					APPROVED BY:JS





CUNNINGHAM HILL SANTA FE COUNTY, NEW MEXICO


CUNNINGHAM HILL WASTE ROCK PILE IMPROVEMENTS SANTA FE COUNTY, NM


BENCH PROFILES AND SECTIONS II


JOB NO. DB22.1087


SHEET 5 OF 8

DWG NO. C-3

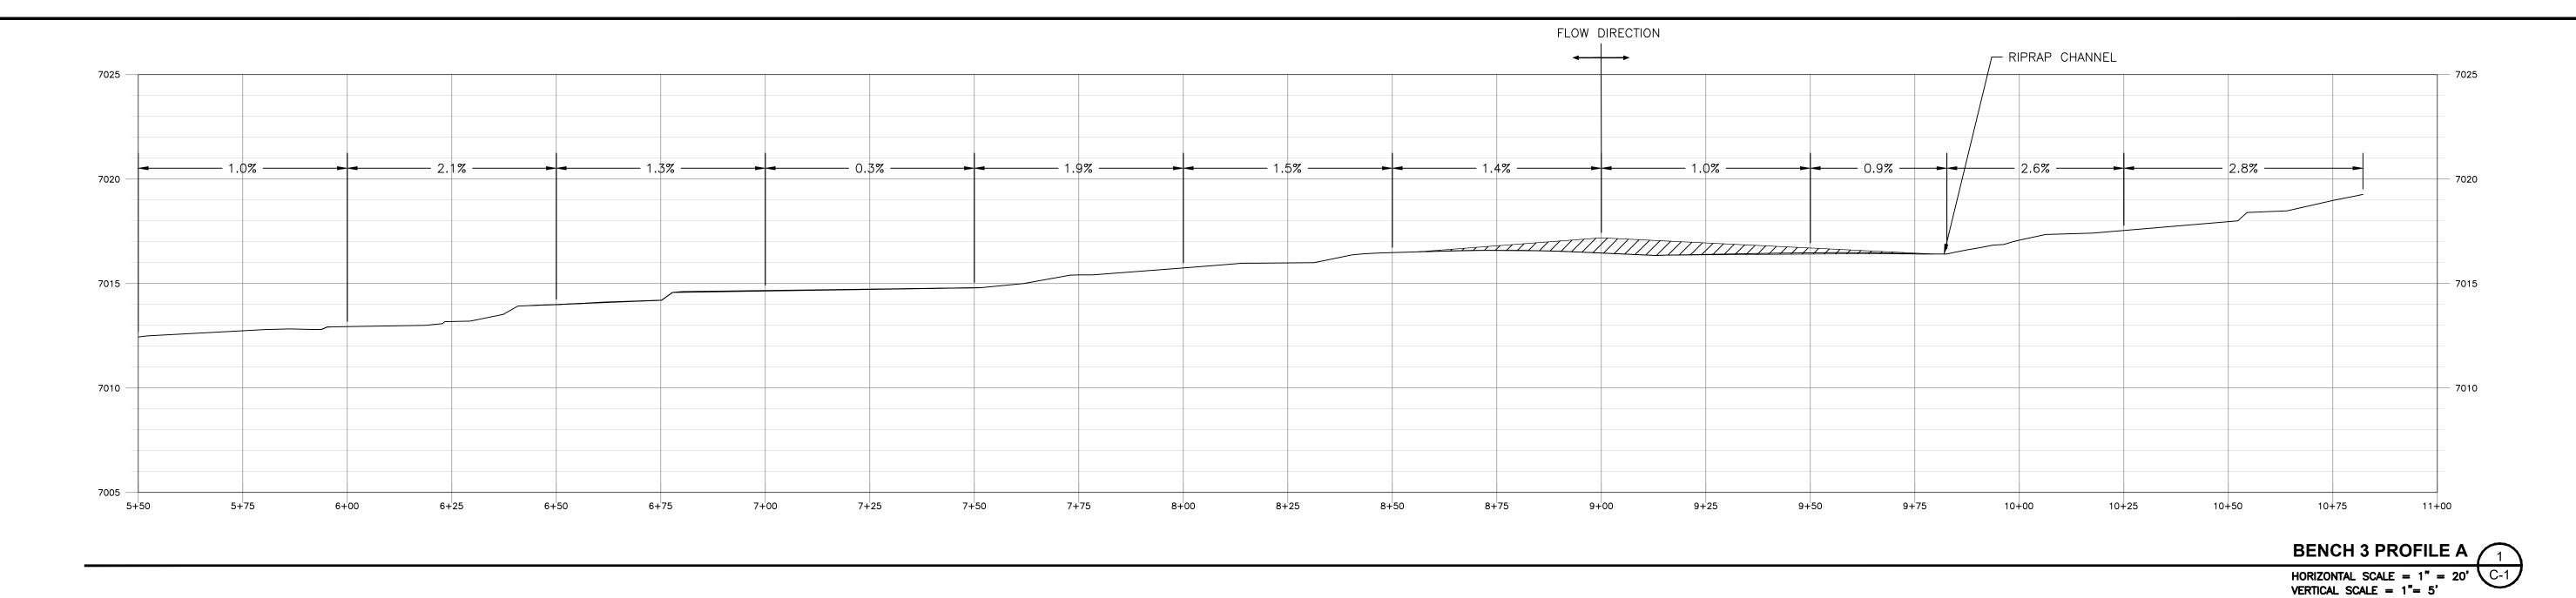


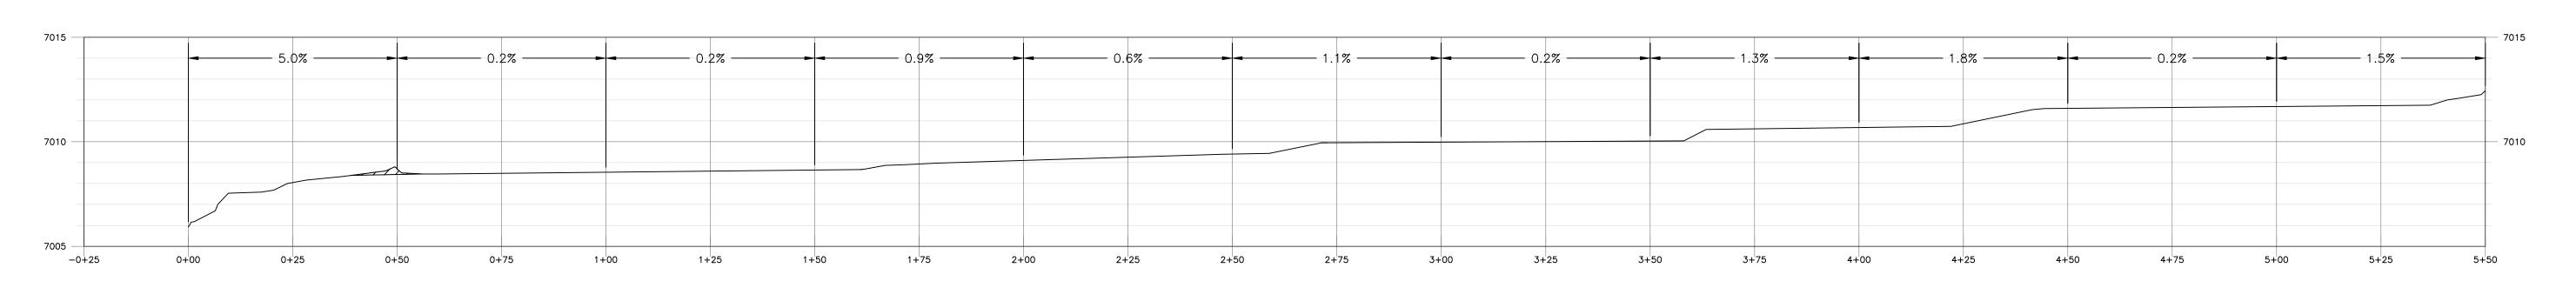

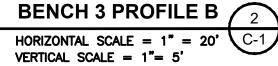

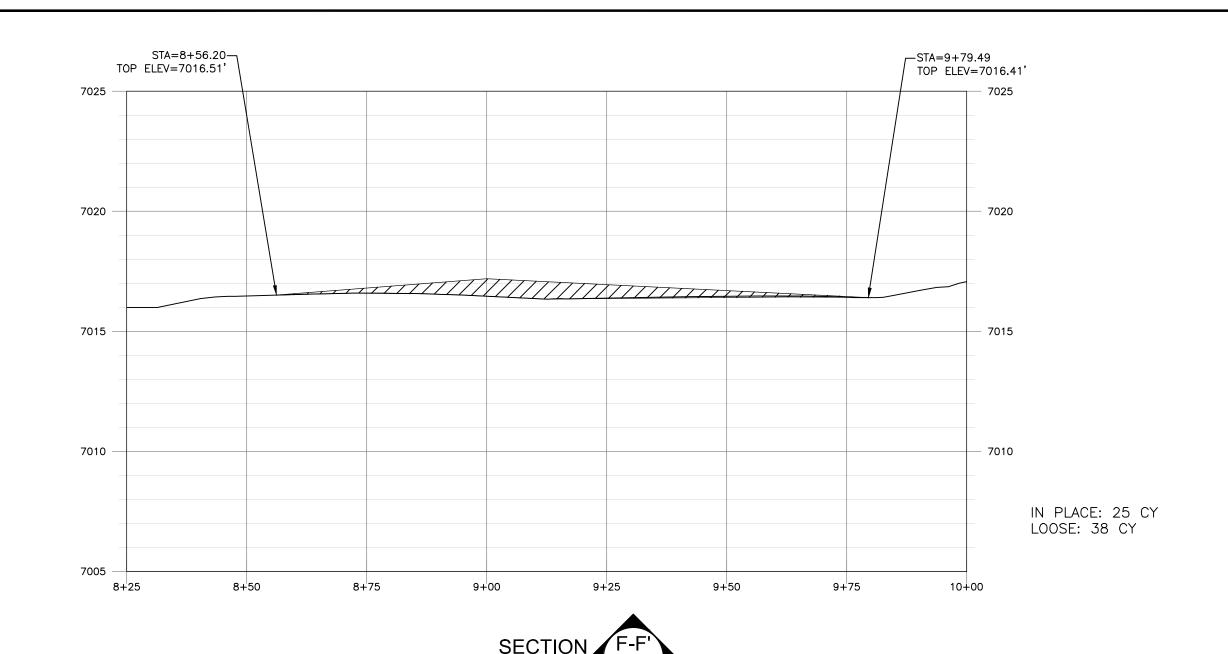

HORIZONTAL SCALE = 1" = 20' C-1 VERTICAL SCALE = 1"= 5'

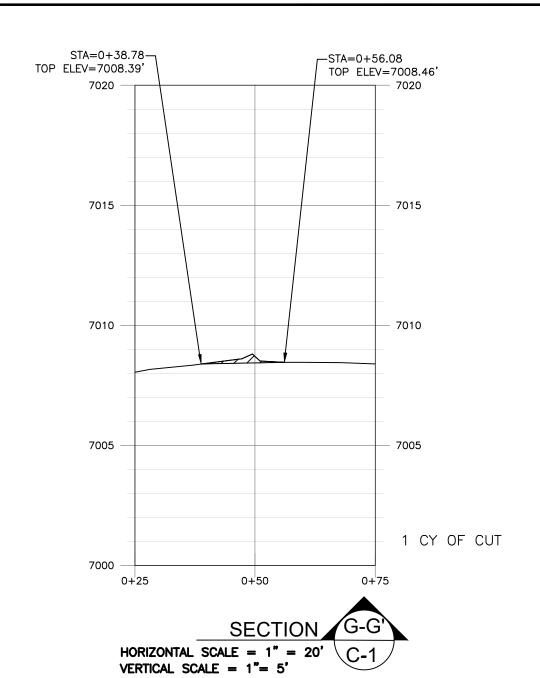

	REV. NO.	DATE	DESCRIPTION	APPROVED BY	DATE OF ISSUE:	09/24/2022
	0	05/19/2022	ISSUED FOR CONSTRUCTION	JES	DAIL OF ISSUE.	08/24/2022
١	1	08/24/2022	ISSUED FOR CONSTRUCTION	JES	DESIGNED BY:	JS
	2	09/09/2022	ISSUED FOR CONSTRUCTION	JES	DRAWN BY:	JA
						00 / 10 4
۱					CHECKED BY:	GP/JPA
ı					APPROVED BY:	JS







CUNNINGHAM HILL SANTA FE COUNTY, NEW MEXICO CUNNINGHAM HILL WASTE ROCK PILE IMPROVEMENTS SANTA FE COUNTY, NM

BENCH PROFILES AND SECTIONS III

SHEET 6 OF 8 DWG NO. C-4

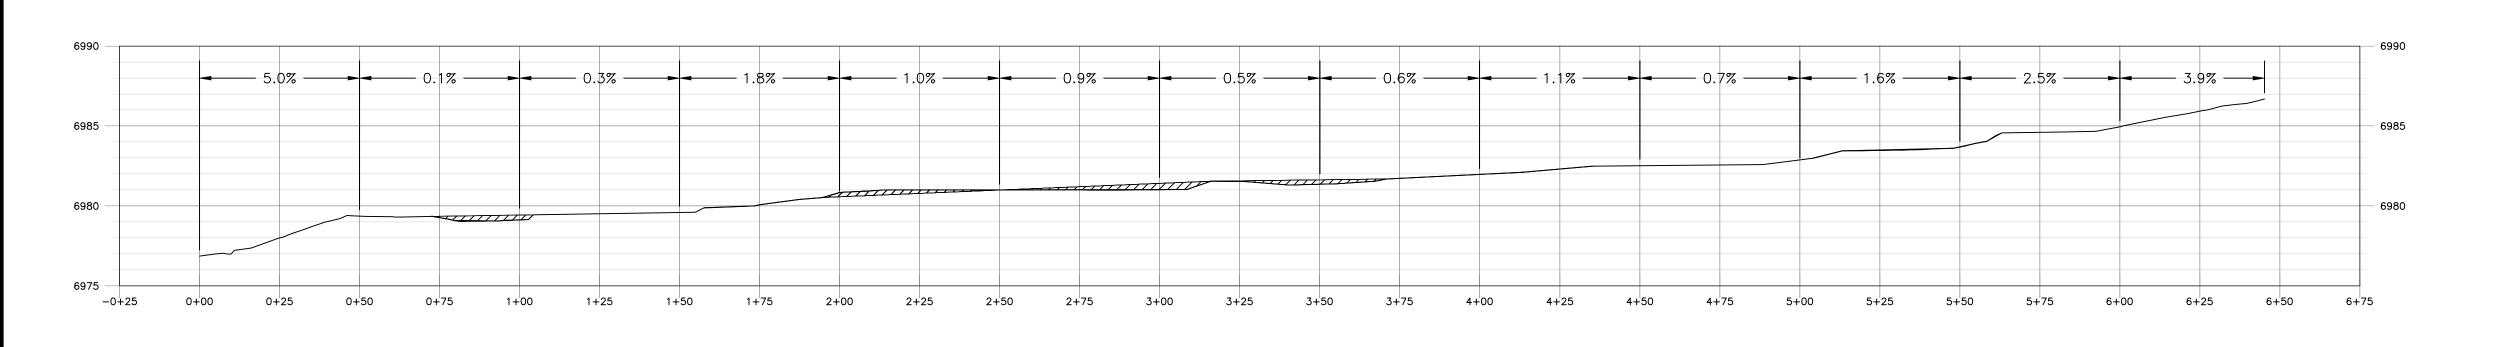


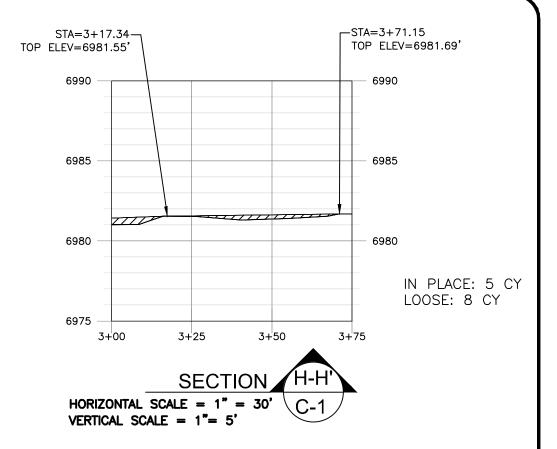


BENCH 4 PROFILE

HORIZONTAL SCALE = 1" = 30'

VERTICAL SCALE = 1" = 5'

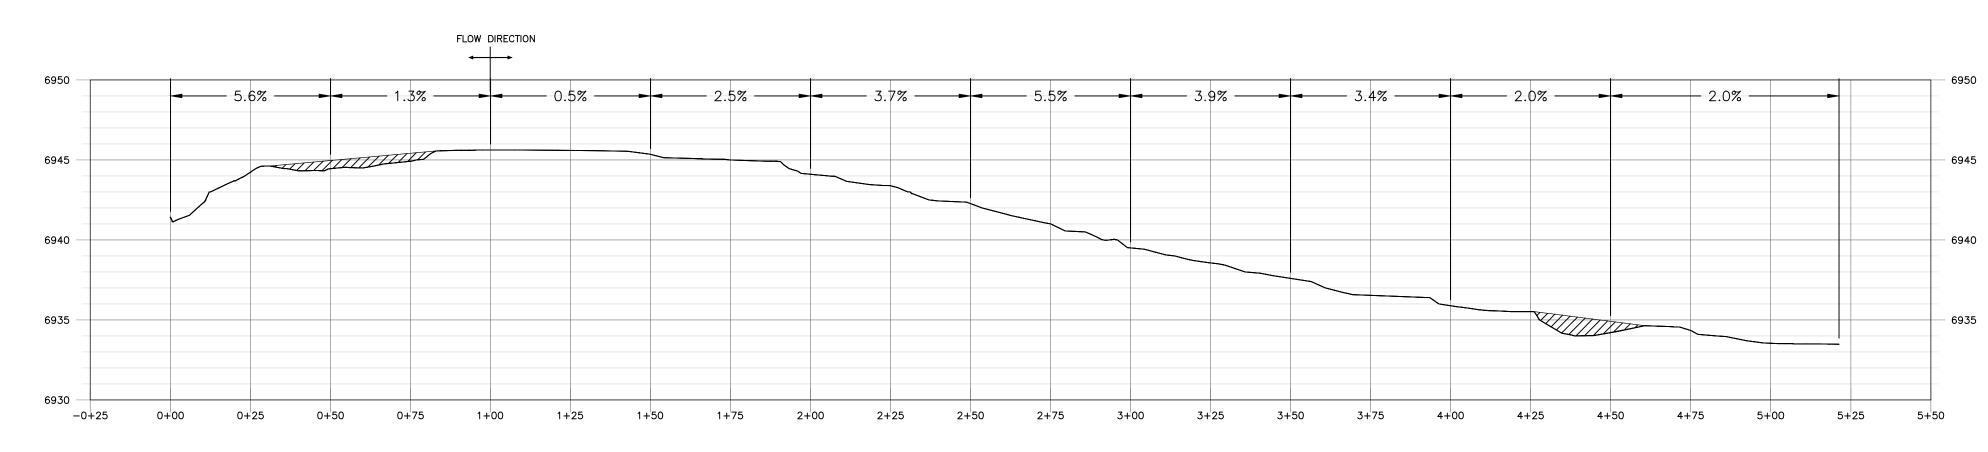


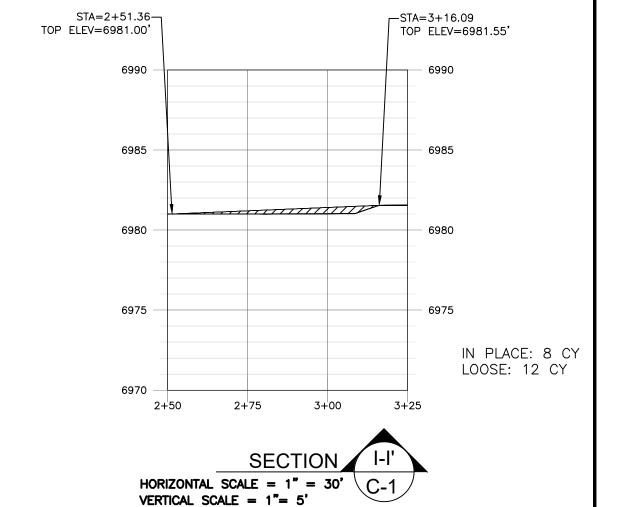



BENCH 5 PROFILE

HORIZONTAL SCALE = 1" = 50'


VERTICAL SCALE = 1" = 5'

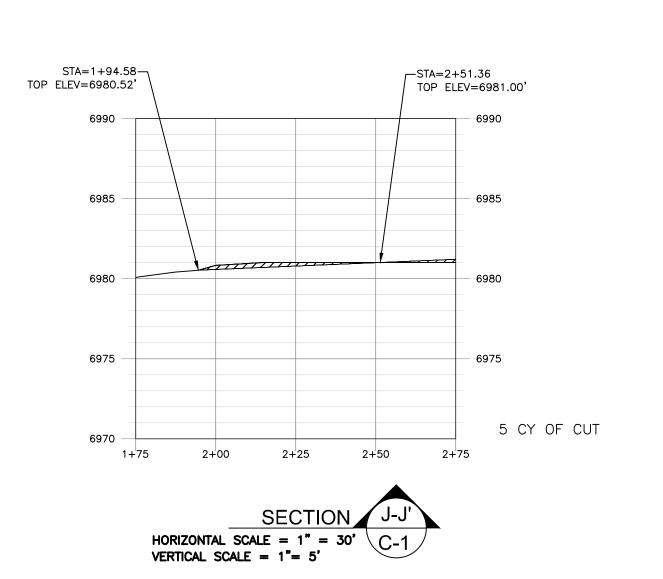

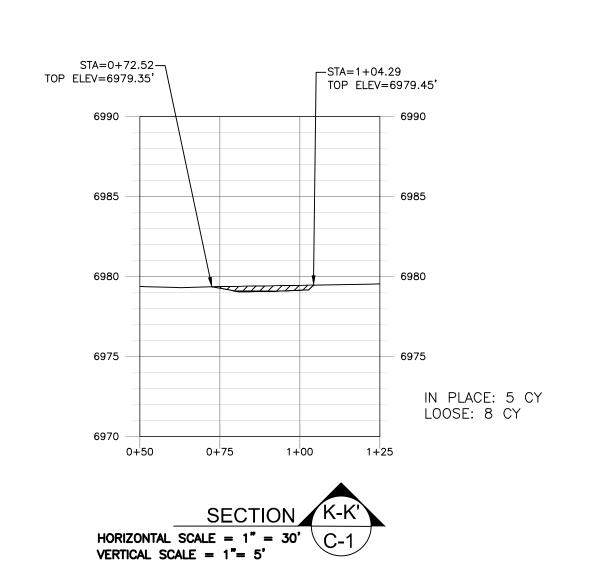

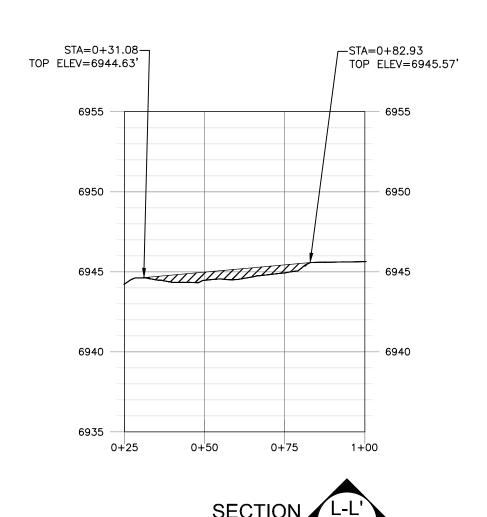

HORIZONTAL SCALE = 1" = 30'
VERTICAL SCALE = 1" = 5'

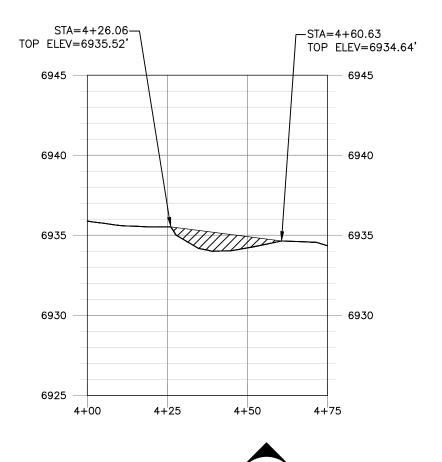

HORIZONTAL SCALE = 1" = 30' C-1 VERTICAL SCALE = 1"= 5'

REV. NO.	DATE	DESCRIPTION	APPROVED BY	DATE OF ISSUE: 08/24/2022
0	05/19/2022	ISSUED FOR CONSTRUCTION	JES	DATE OF 1330E
1	08/24/2022	ISSUED FOR CONSTRUCTION	JES	DESIGNED BY:JS
2	09/09/2022	ISSUED FOR CONSTRUCTION	JES	DRAWN BY: JA
				CHECKED BY:GP/JPA
				APPROVED BY: JS






CUNNINGHAM HILL SANTA FE COUNTY, NEW MEXICO CUNNINGHAM HILL
WASTE ROCK PILE IMPROVEMENTS
SANTA FE COUNTY, NM

BENCH PROFILES IV

SHEET 7 OF 8 DWG NO. C-5

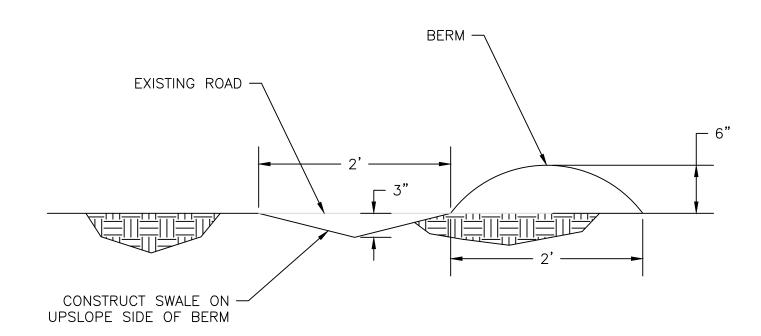

BUILD UP EDGE OF SLOPE

15'

6"

SCALE: NTS C-1

BENCH DETAIL 2

SCALE: NTS C-1

	REV. NO.	DATE	DESCRIPTION	APPROVED BY	DATE OF ISSUE: 08/24/2022
766.	0	05/19/2022	ISSUED FOR CONSTRUCTION	JES	DATE OF 1330E
	1	08/24/2022	ISSUED FOR CONSTRUCTION	JES	DESIGNED BY:JS
	2	09/09/2022	ISSUED FOR CONSTRUCTION	JES	DRAWN BY: JA
2					
> 5					CHECKED BY:GP/JPA
					APPROVED BY: JS





CUNNINGHAM HILL SANTA FE COUNTY, NEW MEXICO CUNNINGHAM HILL
WASTE ROCK PILE IMPROVEMENTS
SANTA FE COUNTY, NM
CIVIL DETAILS

SHEET 8 OF 8 DWG NO. C-6