


### APPENDIX A TYRONE MINE SITE CLOSURE CLOSEOUT PLAN COLORADO April 2020 LIST OF DRAWINGS OKLAHOMA Rev. 3- Revised Client Comments DRAWING NO. **DRAWING TITLE COVER SHEET** MINE SITE - OVERALL OVERALL GRADING SITE PLAN 1A LEACH, 1B LEACH AND RECLAIMED 1C WASTE 1A LEACH, 1B LEACH AND RECLAIMED 1C WASTE - GRADING AND DRAINAGE PLAN SANTA FE Gallup DAM 3 6. 1A LEACH, 1B LEACH AND RECLAIMED 1C WASTE - CUT/FILL ISOPACH MAP 7. 1A LEACH, 1B LEACH AND RECLAIMED 1C WASTE - CROSS SECTIONS DAM 3X *ALBUQUERQUE* 8. 2A LEACH, 2B LEACH AND 2B WASTE 9. 2A LEACH, 2B LEACH AND 2B WASTE - GRADING AND DRAINAGE PLAN 10. 2A LEACH, 2B LEACH AND 2B WASTE - CUT/FILL ISOPACH MAP DAM 2 11. 2A LEACH. 2B LEACH AND 2B WASTE - CROSS SECTIONS 12. 2 LEACH (AREAS 1 AND 2), 7B LEACH, 7B WASTE, 7C WASTE AND SAN SALVADOR M E X V C O13. 2 LEACH (AREAS 1 AND 2), 7B LEACH, 7B WASTE, 7C WASTE AND SAN SALVADOR WASTE BACKFILL - GRADING AND DRAINAGE PLAN 14. 2 LEACH (AREAS 1 AND 2), 7B LEACH, 7B WASTE, 7C WASTE AND SAN SALVADOR SERIES 1 TAILING DAMS WASTE BACKFILL - CUT/FILL ISOPACH MAP 15. 2 LEACH (AREAS 1 AND 2), 7B LEACH, 7B WASTE, 7C WASTE AND SAN SALVADOR WASTE BACKFILL - CROSS SECTIONS 16. 3A LEACH AND 3B WASTE STOCKPILES 17. 3A LEACH AND 3B WASTE STOCKPILES - GRADING AND DRAINAGE PLAN Truth or Consequences 18. 3A LEACH AND 3B WASTE STOCKPILES - CUT/FILL ISOPACH MAP Silver City 152 82 19. 3A LEACH AND 3B WASTE STOCKPILES - CROSS SECTIONS - 1 Alamogordo MINE SITE 20. 3A LEACH AND 3B WASTE STOCKPILES - CROSS SECTIONS - 2 21. 5A WASTE ■Carlsbad 22. 5A WASTE - GRADING AND DRAINAGE PLAN LAS CRUCES 23. 5A WASTE - CUT/FILL ISOPACH MAP 24. 5A WASTE - CROSS SECTIONS 25. 6A LEACH, 6B LEACH, 6C LEACH AND 6D LEACH 26. 6A LEACH, 6B LEACH, 6C LEACH AND 6D LEACH - GRADING AND DRAINAGE 27. 6A LEACH, 6B LEACH, 6C LEACH AND 6D LEACH - CUT/FILL ISOPACH MAP 28. 6A LEACH, 6B LEACH, 6C LEACH AND 6D LEACH - CROSS SECTIONS Gla Hot Springs 29. 9A WASTE AND 9AX WASTE 30. 9A WASTE AND 9AX WASTE - GRADING AND DRAINAGE 31. 9A WASTE AND 9AX WASTE - CUT/FILL ISOPACH MAP YTHUQO 32. 9A WASTE AND 9AX WASTE- CROSS SECTIONS 33. DRAINAGE DETAILS 34. HAUL ROUTE MAP Silver City Tyrone Mine PREPARED FOR: PREPARED BY: FREEPORT-McMoRAN TYRONE, INC. DENVER, CO


DRAWING No.: REV


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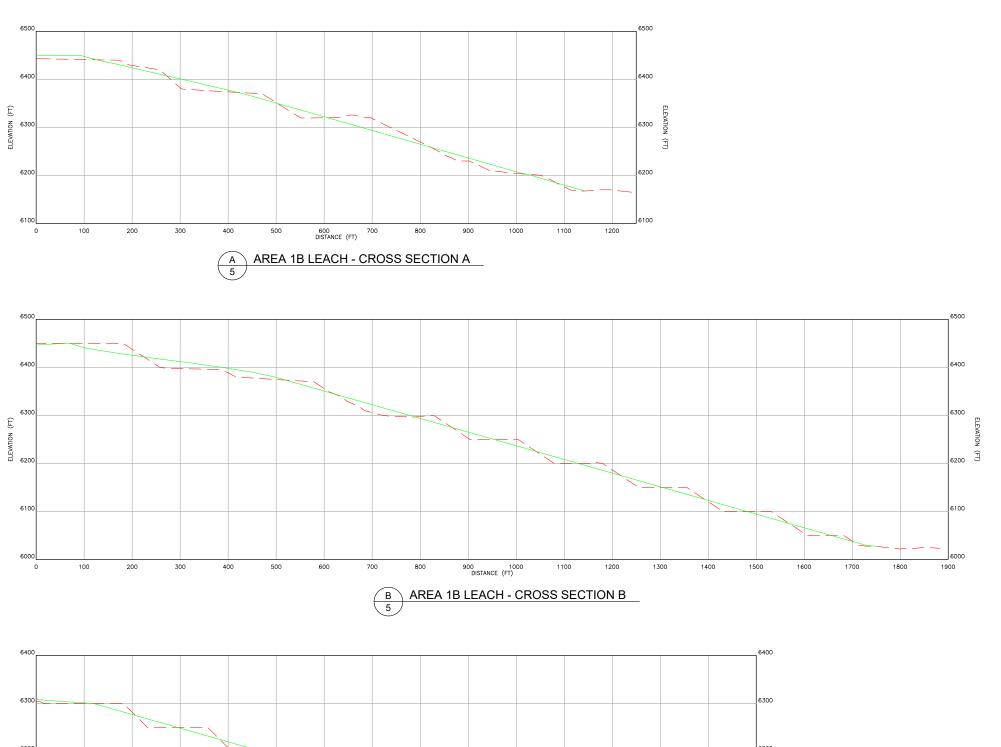


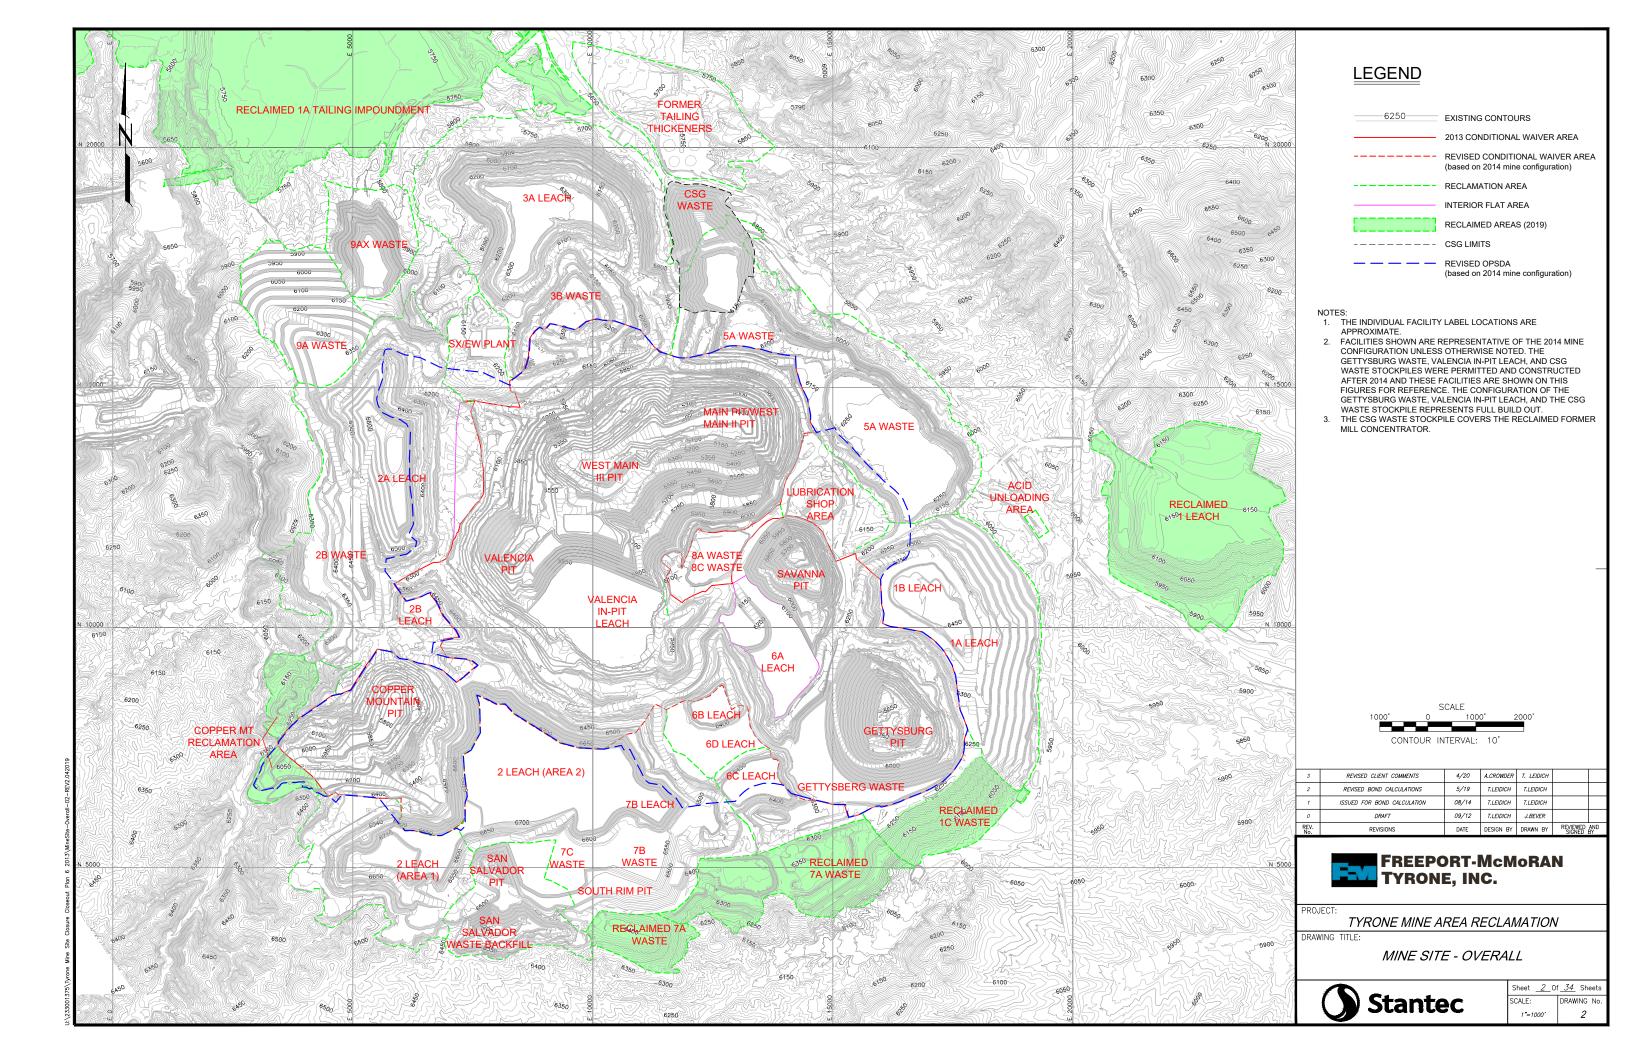


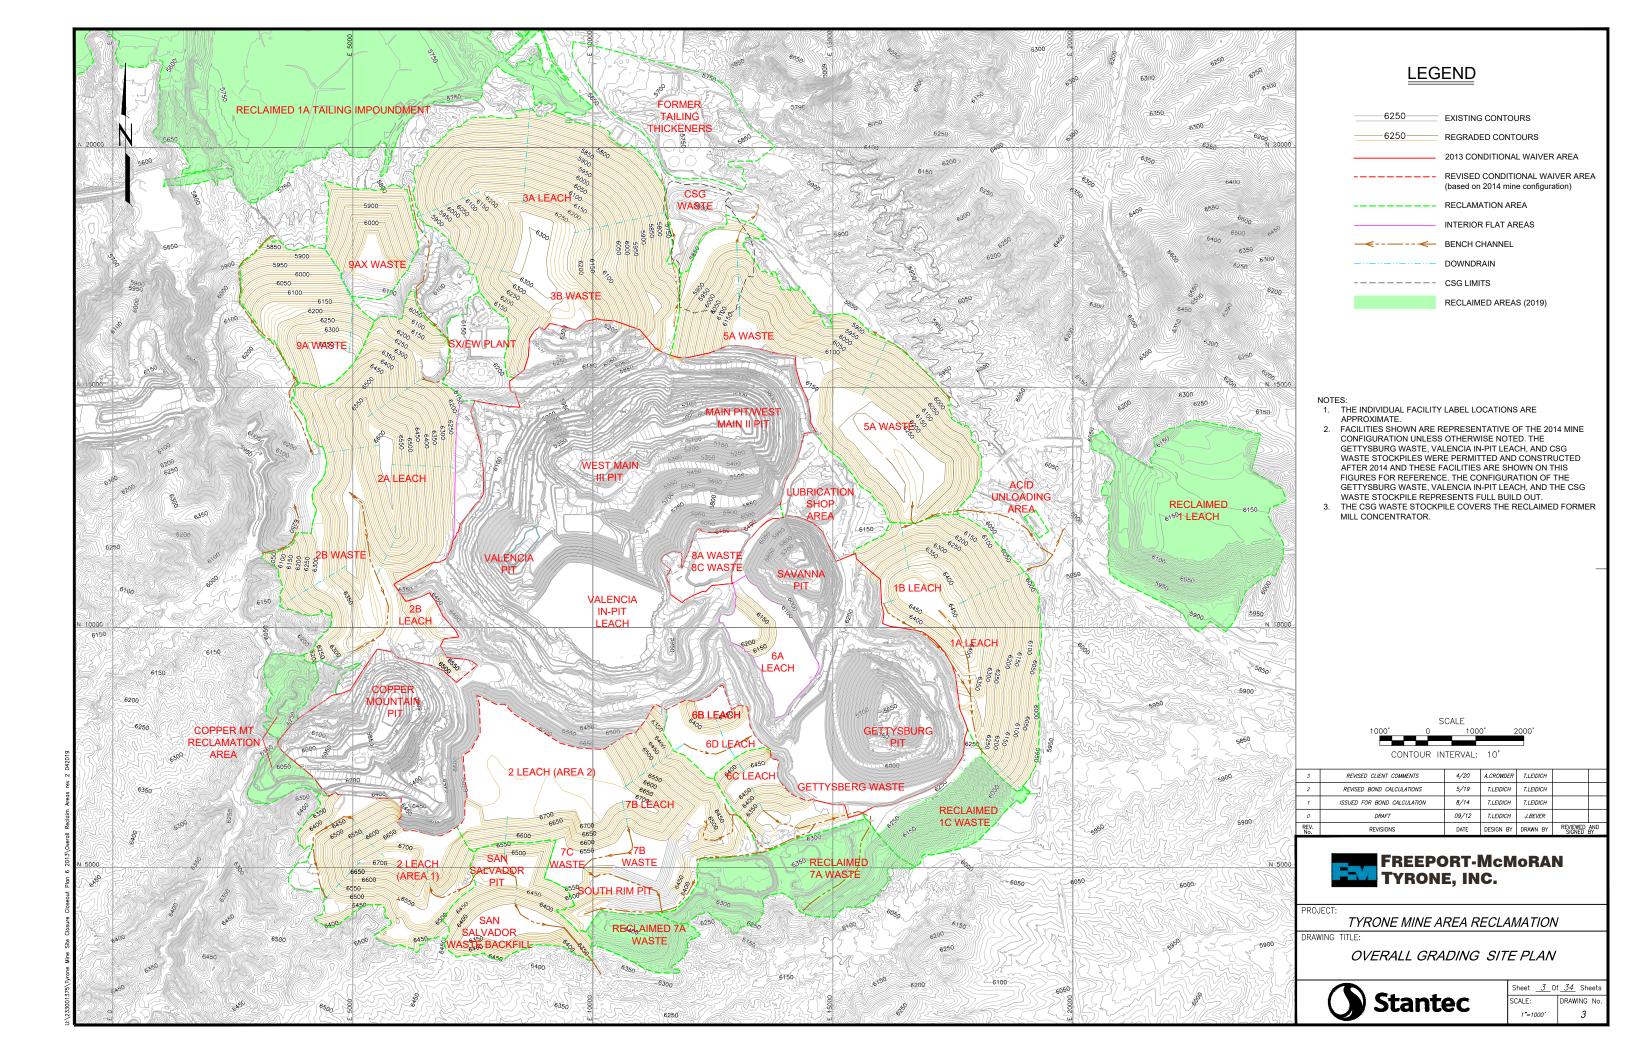

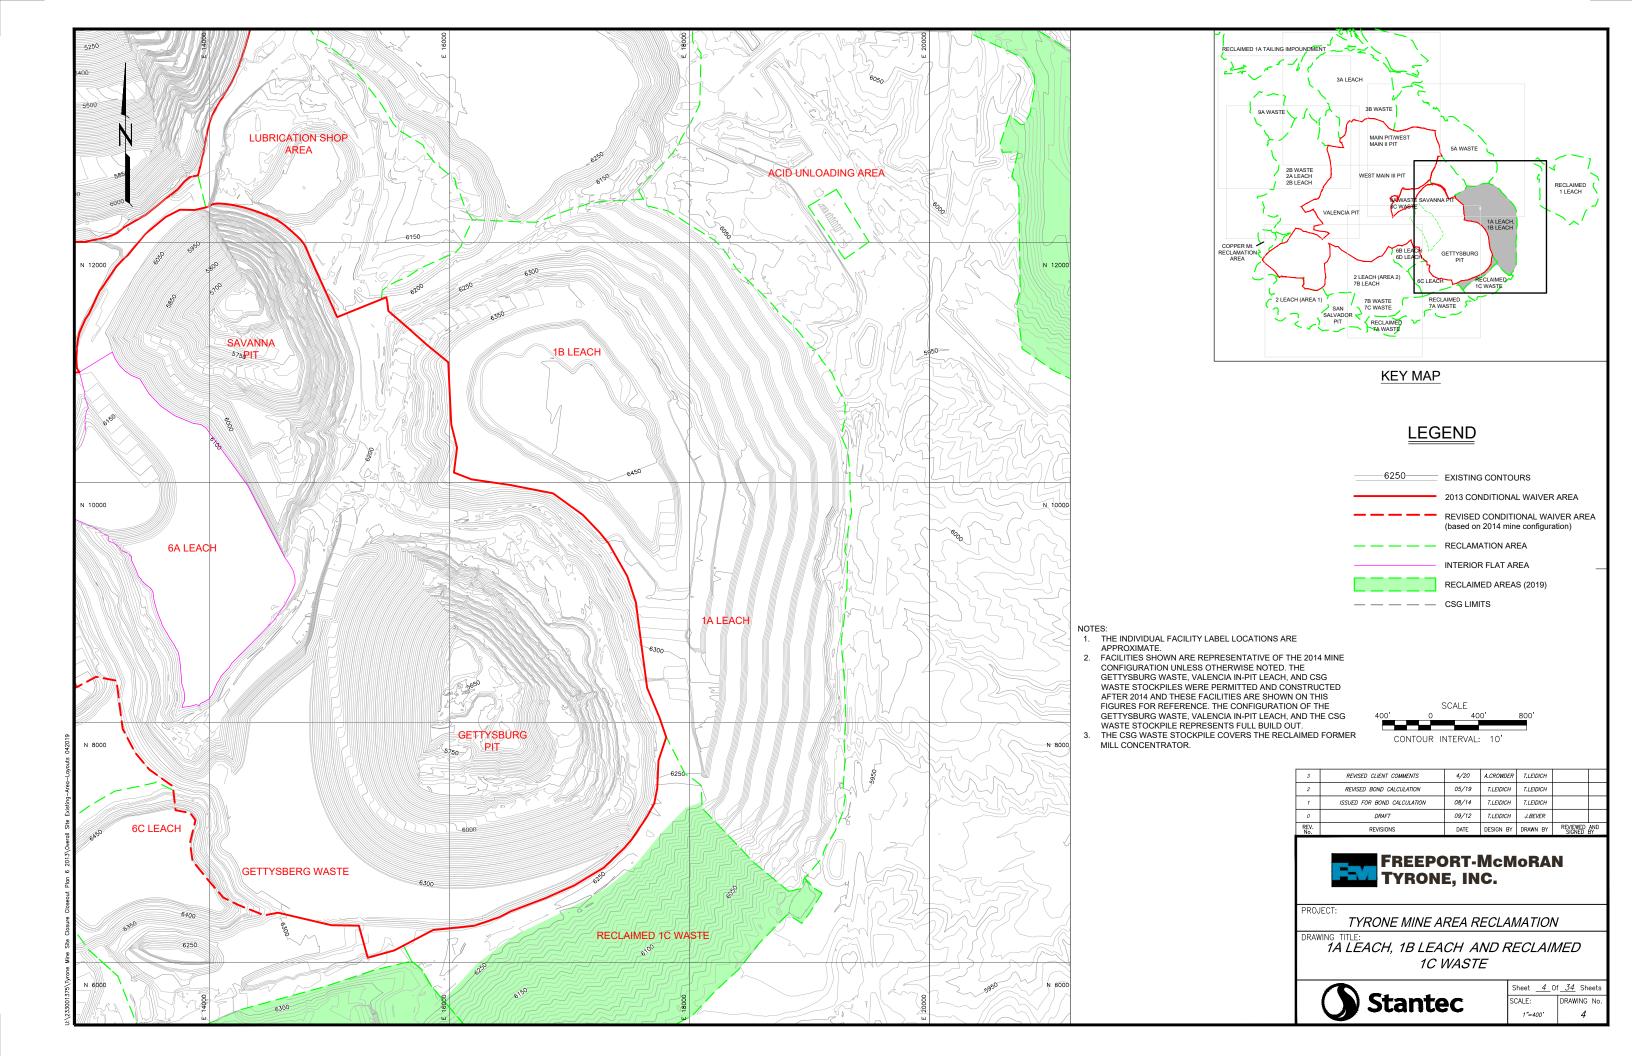

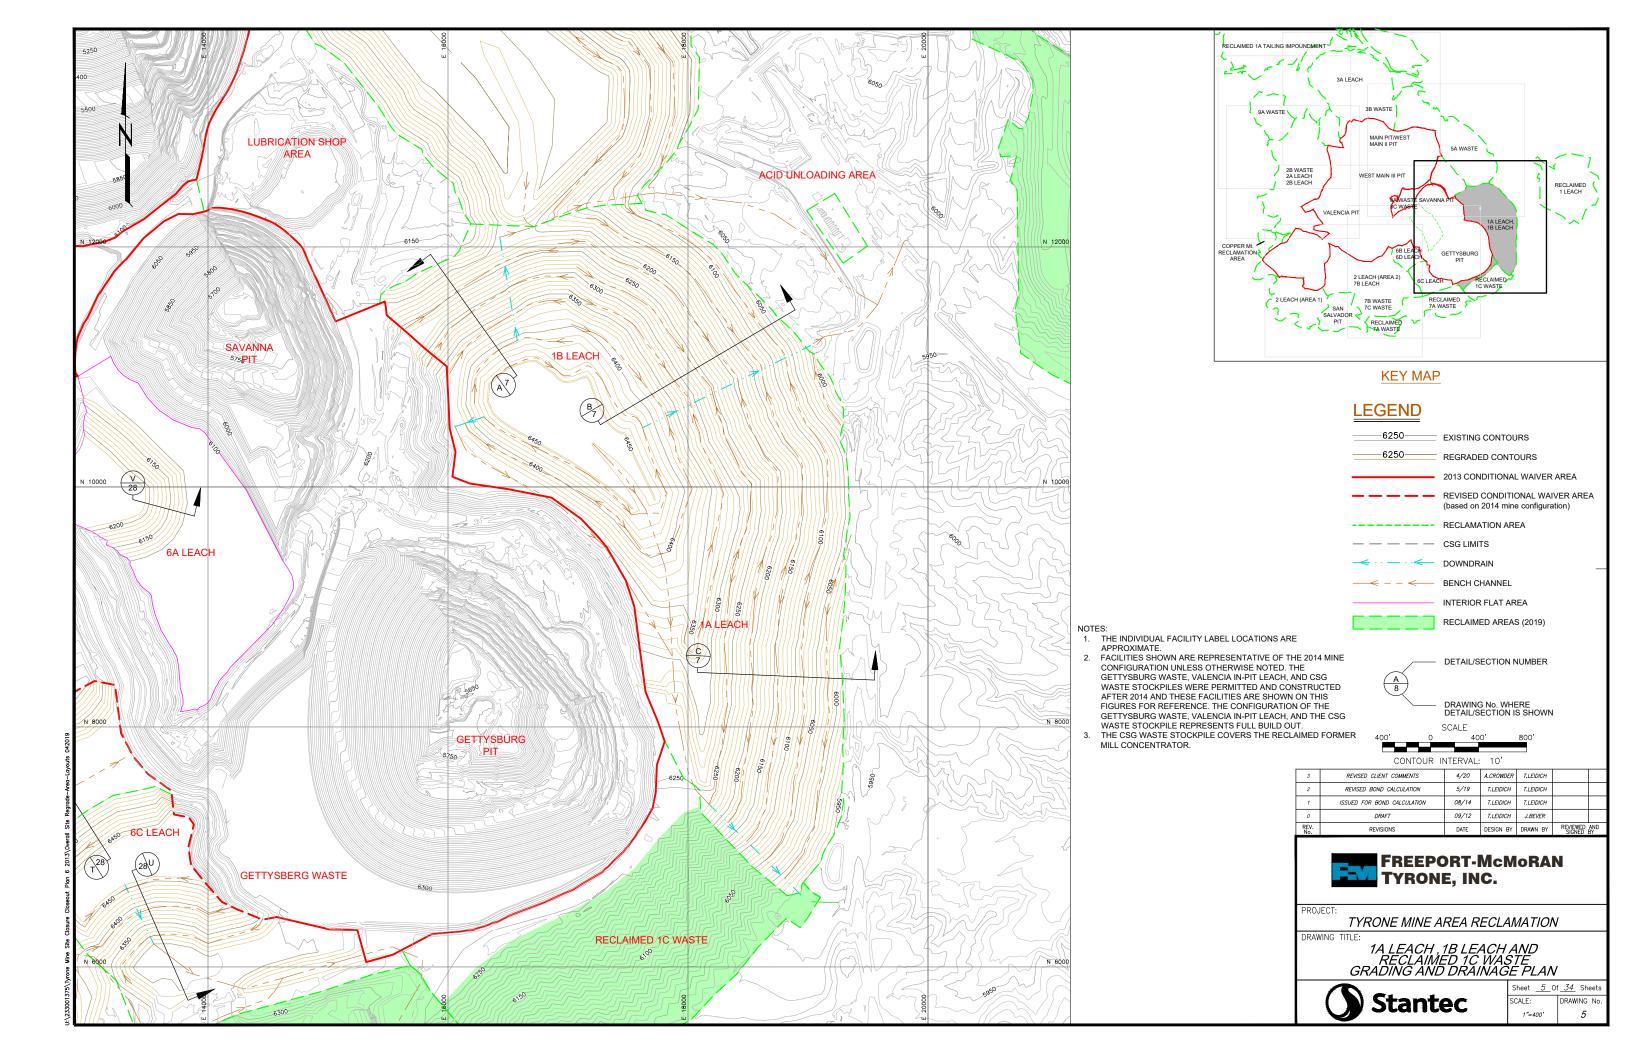

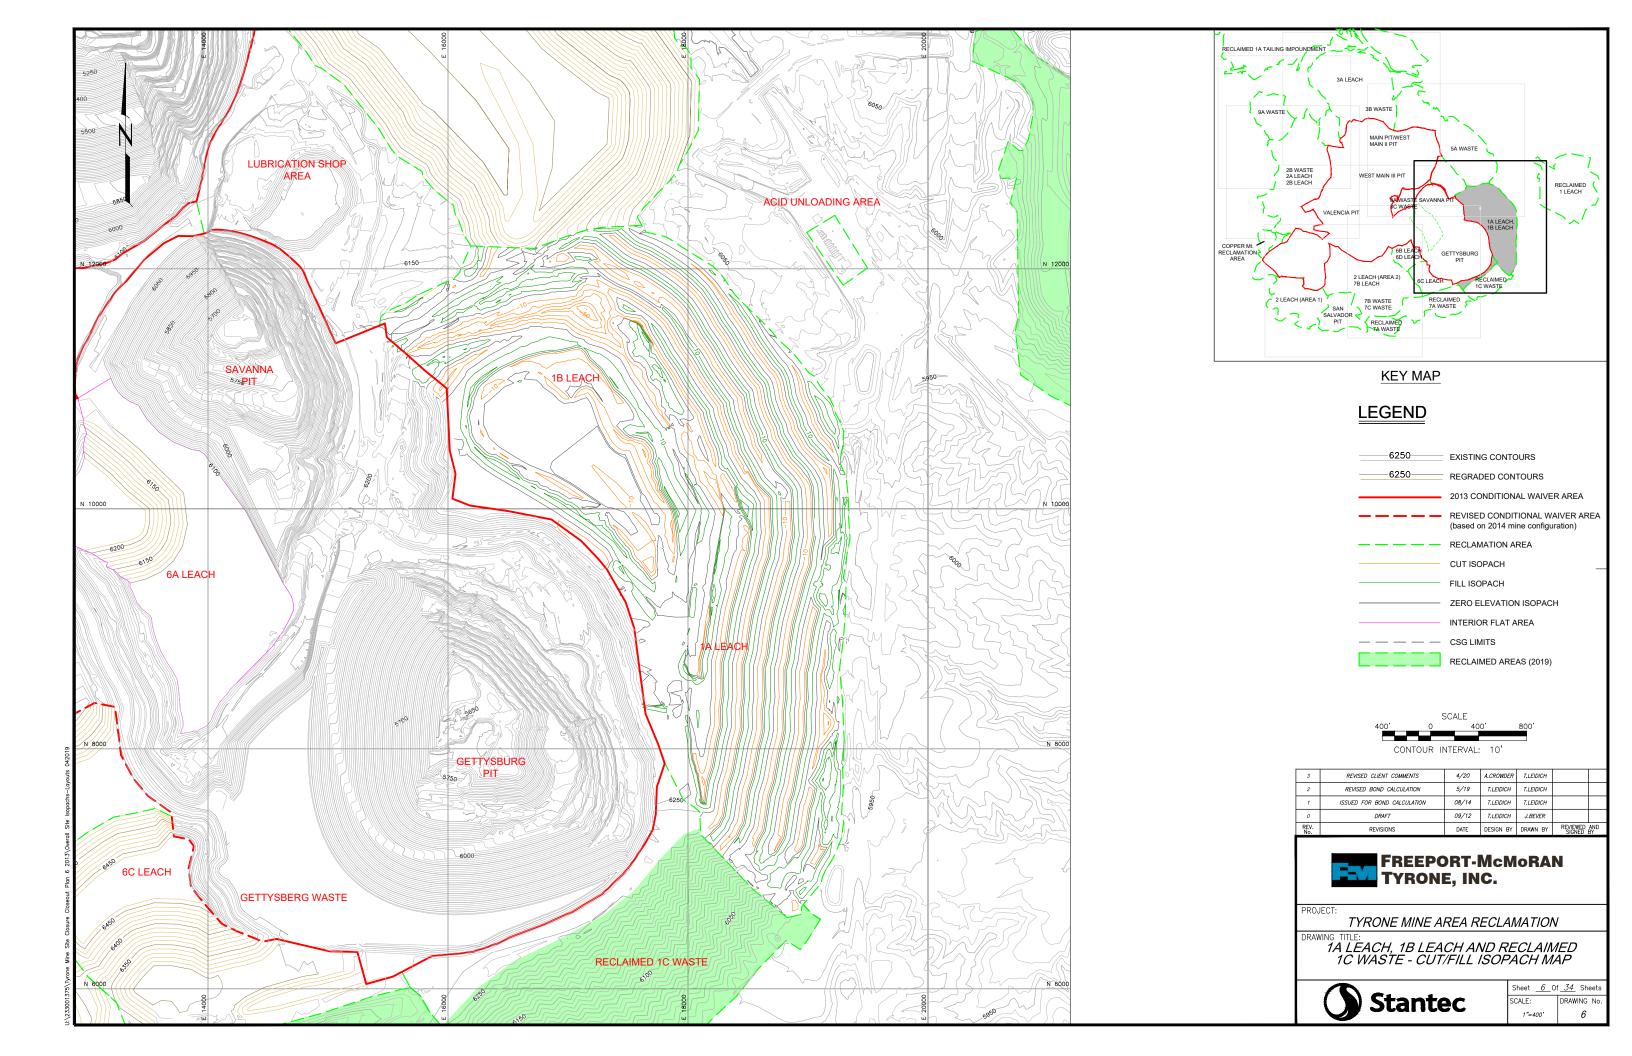

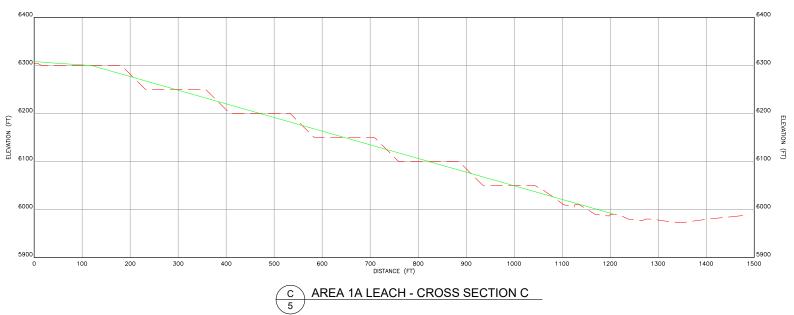

Note: The regrade surface shows the overall slope and does not show the terrace benchs that will be constructed on inter-bench outslope angles of 3H:1V at slope lengths no greater than 200'. For the typical final slope configuration refer to Drawing No. 33

## **LEGEND**

EXISTING GROUND SURFACE

REGRADE SURFACE

DETAIL/SECTION NUMBER





3	REVISED CLIENT COMMENTS	4/20	A.CROWDER	T.LEIDICH		
2	REVISED BOND CALCULATION	5/19	T.LEIDICH	T.LEIDICH		
1	ISSUED FOR BOND CALCULATION	06/13	T.LEIDICH	T.LEIDICH		
0	DRAFT	09/12	T.LEIDICH	J.BEVER		
REV.	REVISIONS	DATE	DESIGN BY	DRAWN BY	REVIEWED	AND



PROJECT:

TYRONE MINE AREA RECLAMATION


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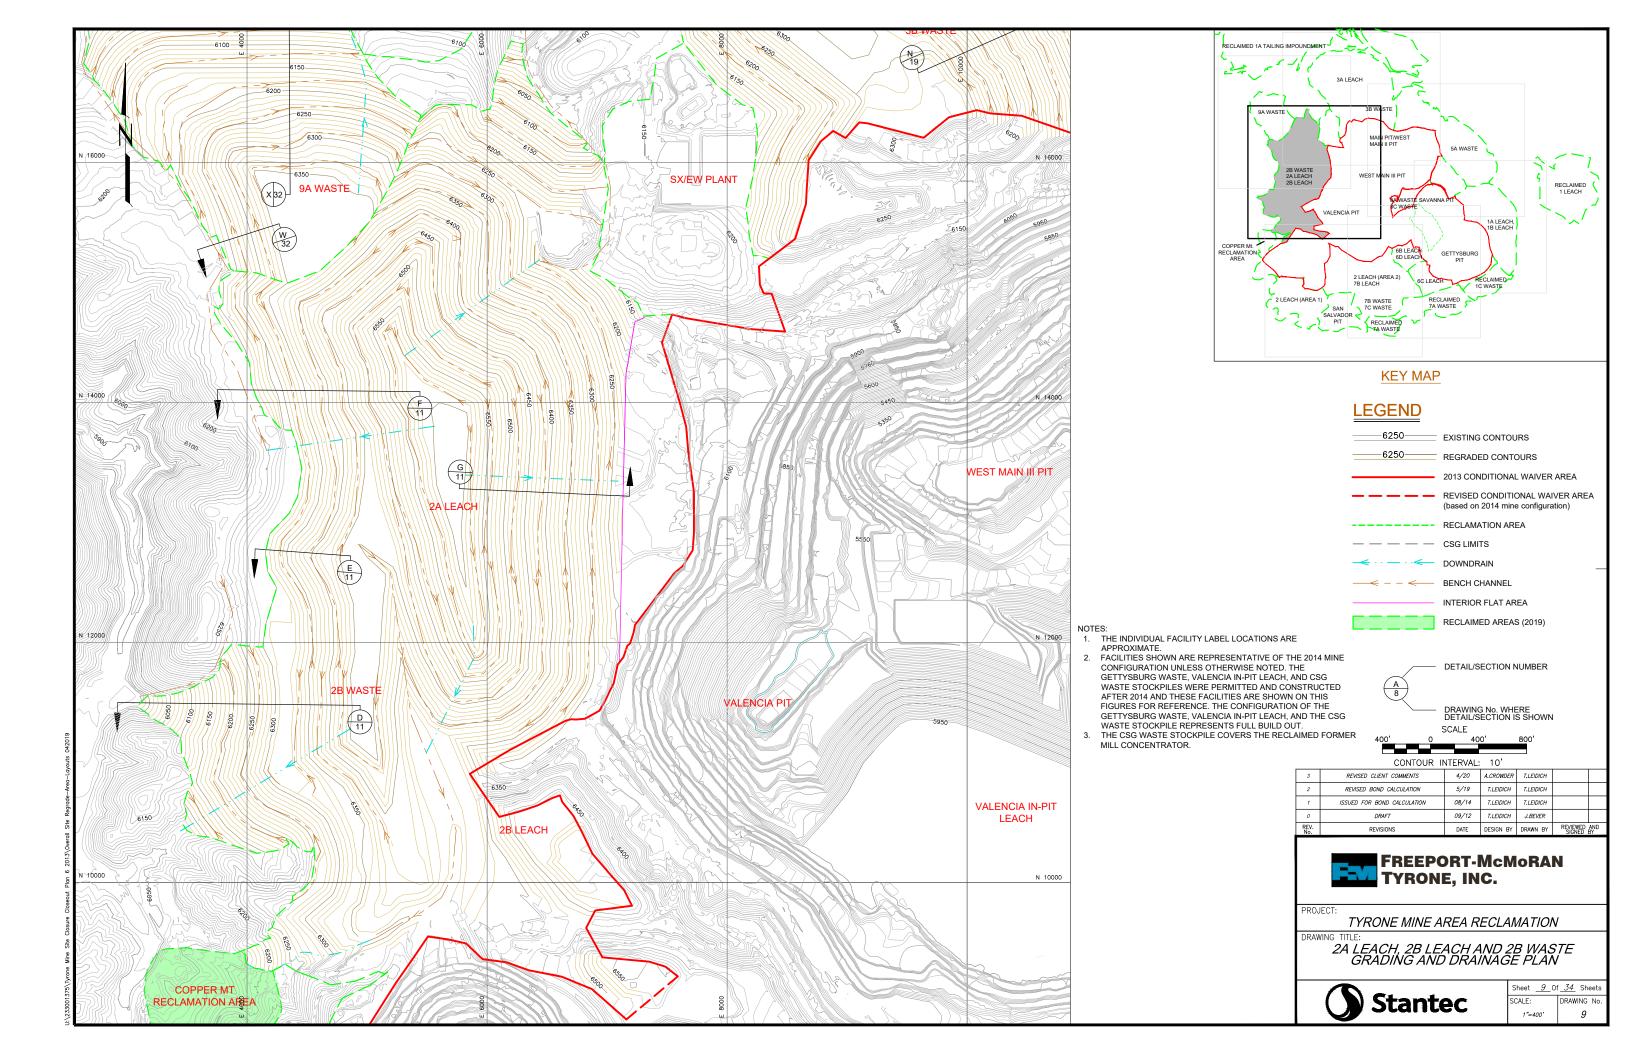
1A LEACH, 1B LEACH AND RECLAIMED


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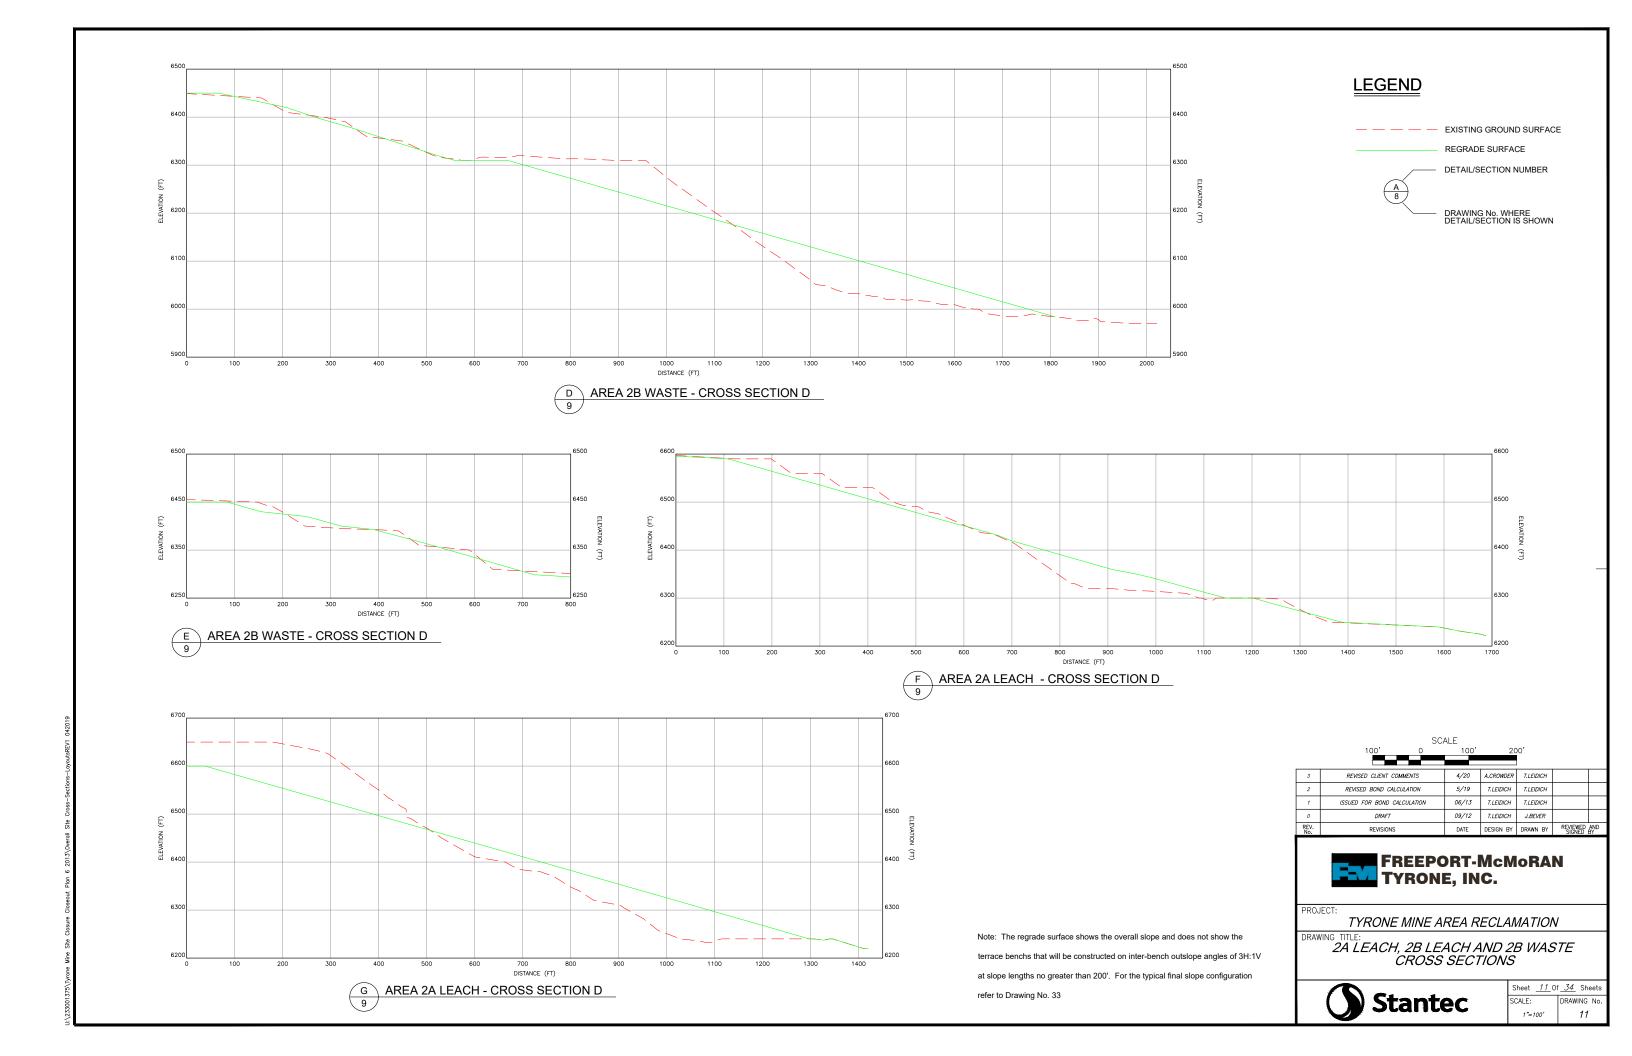



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SCALE: DRAWING No.
1"=100' 7







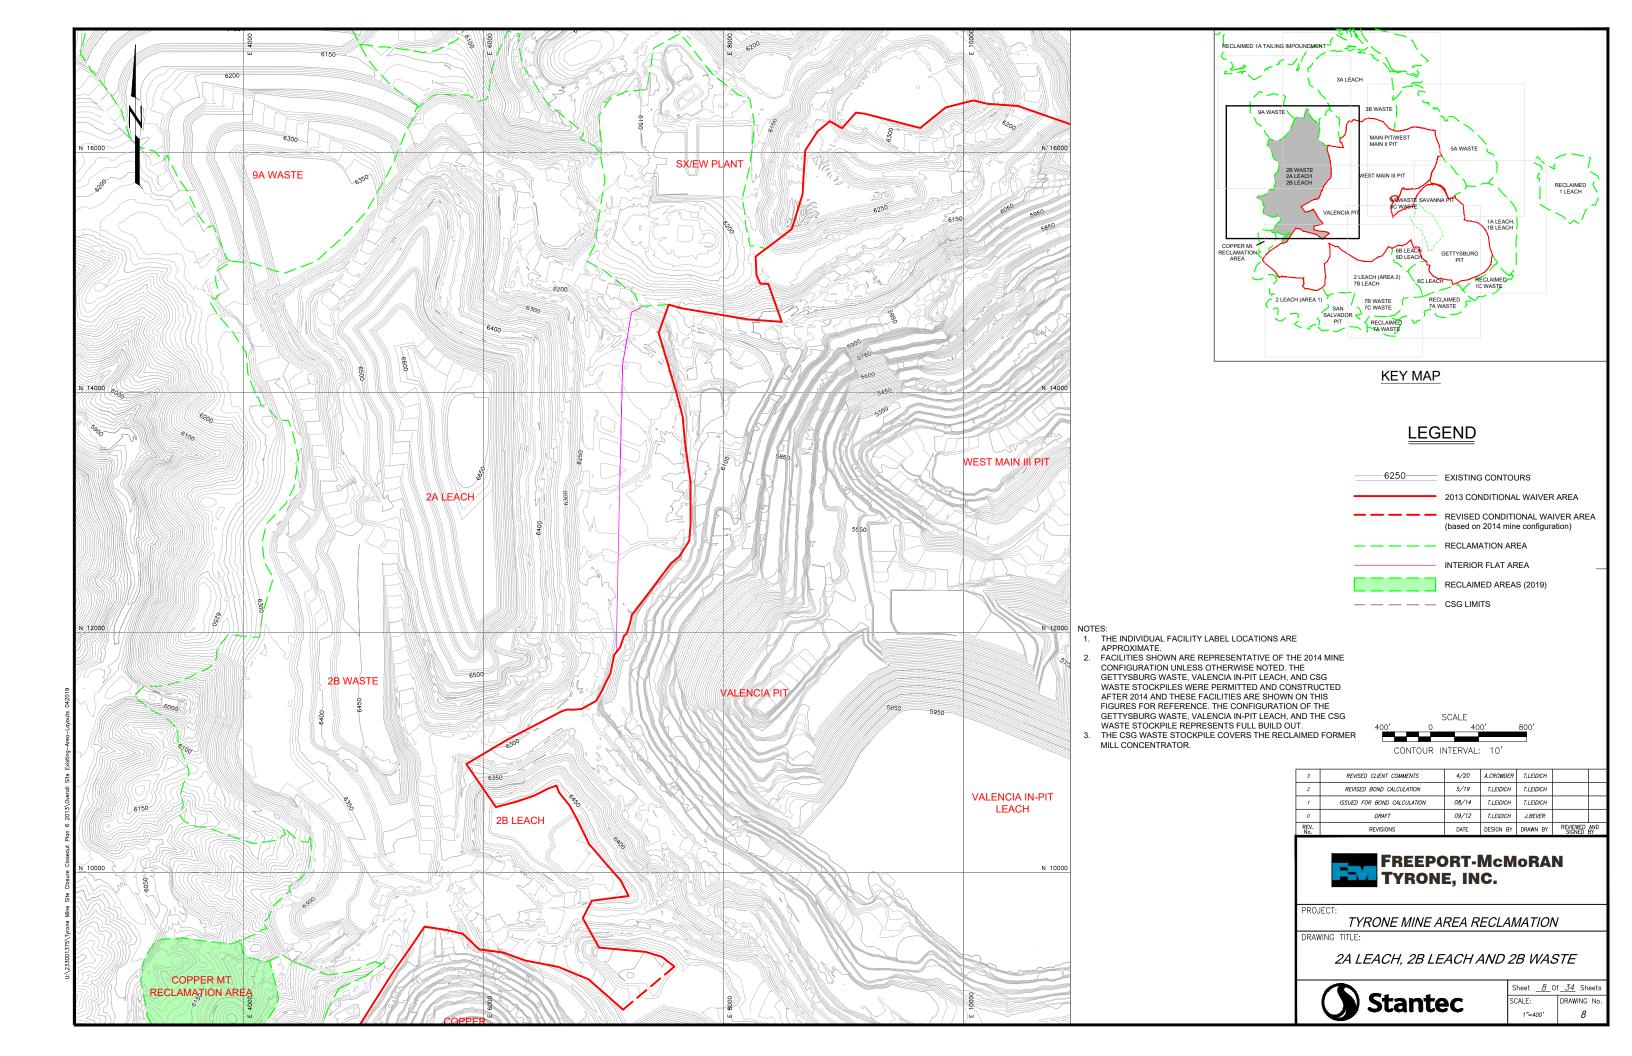


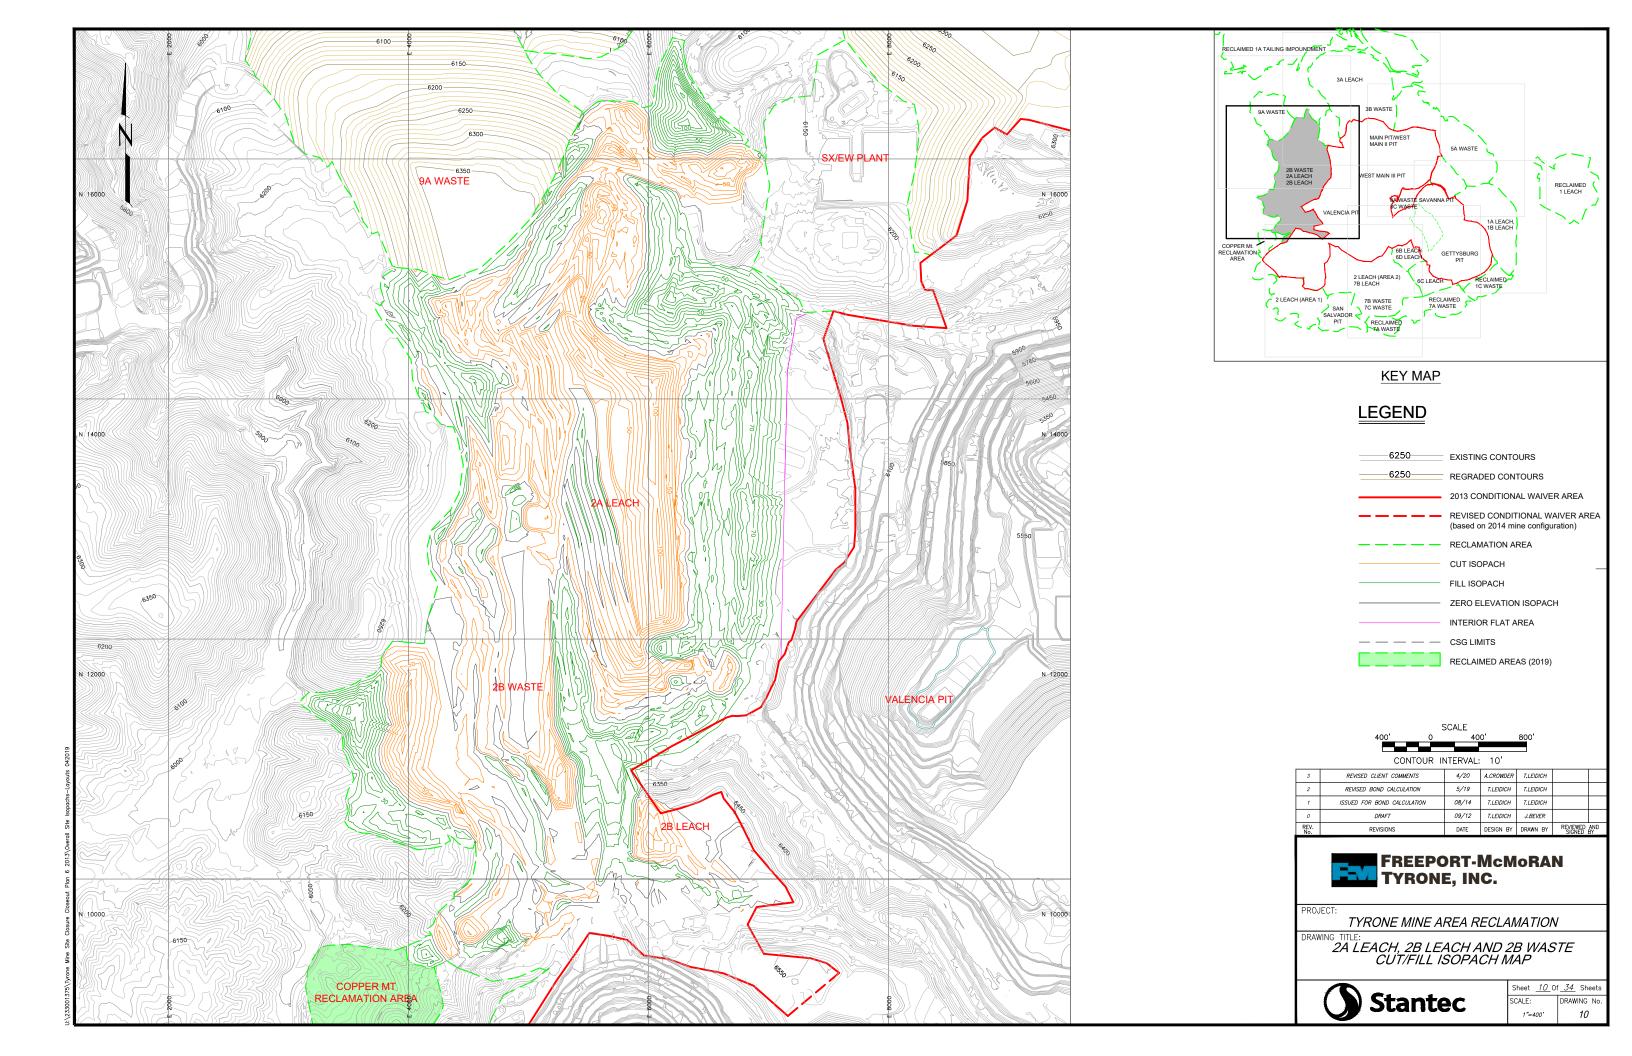


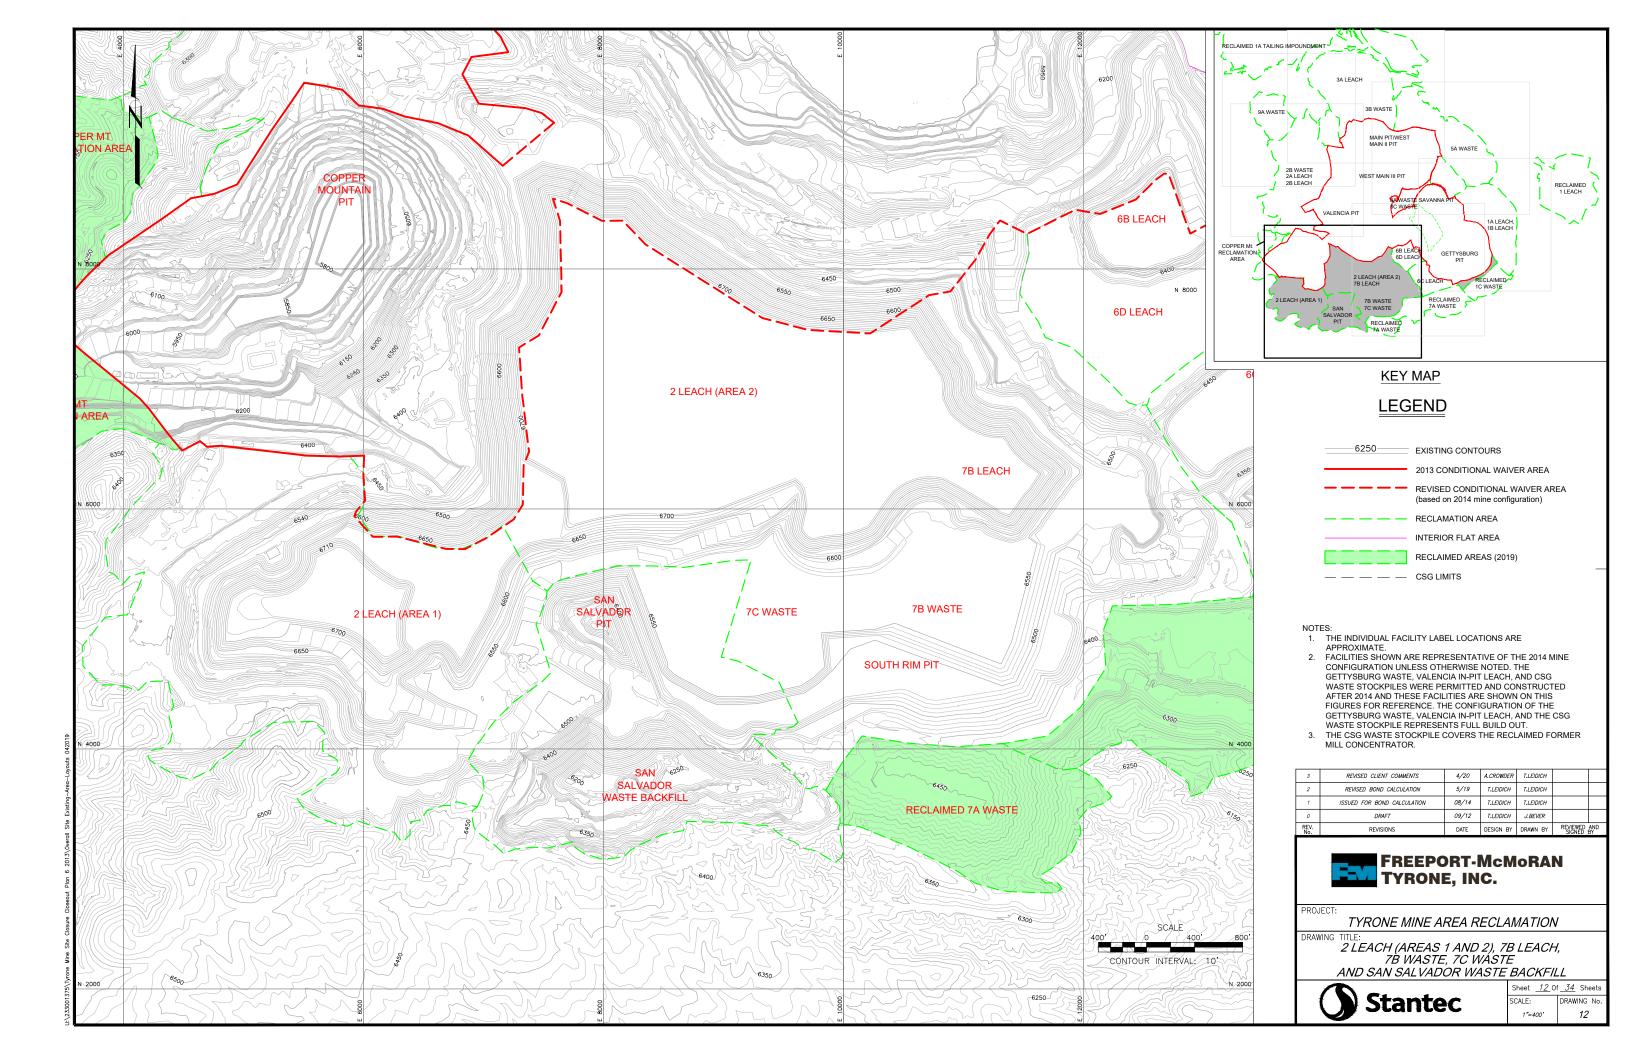


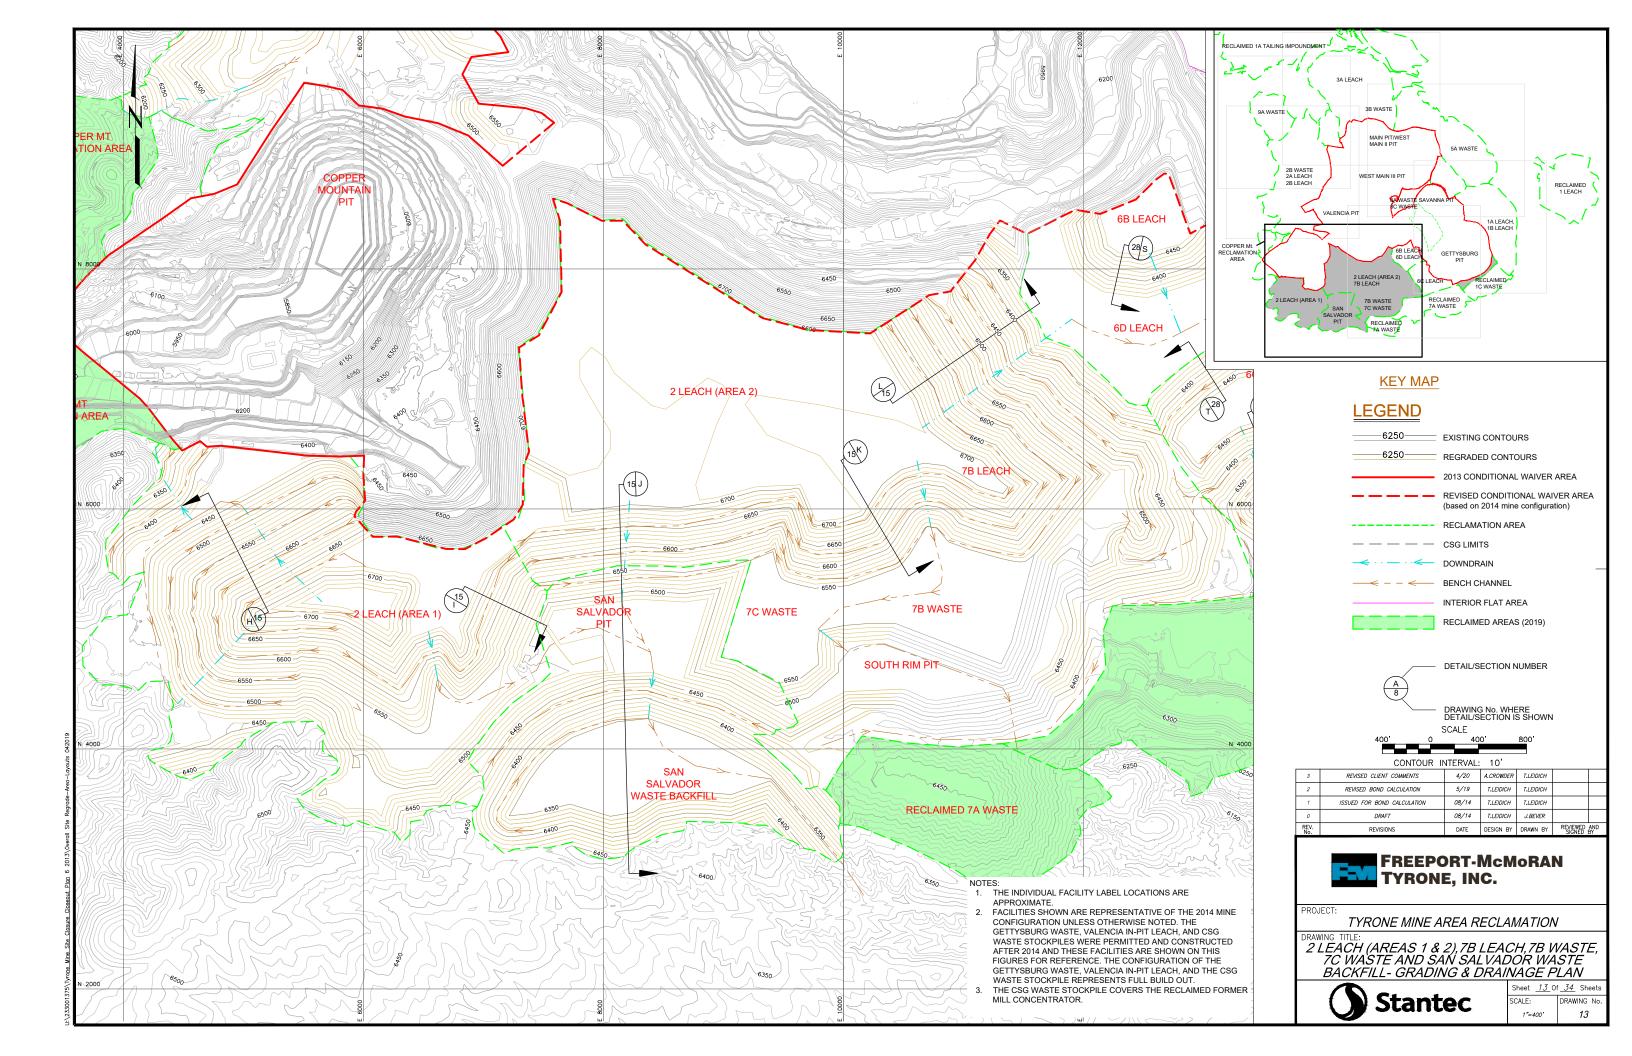


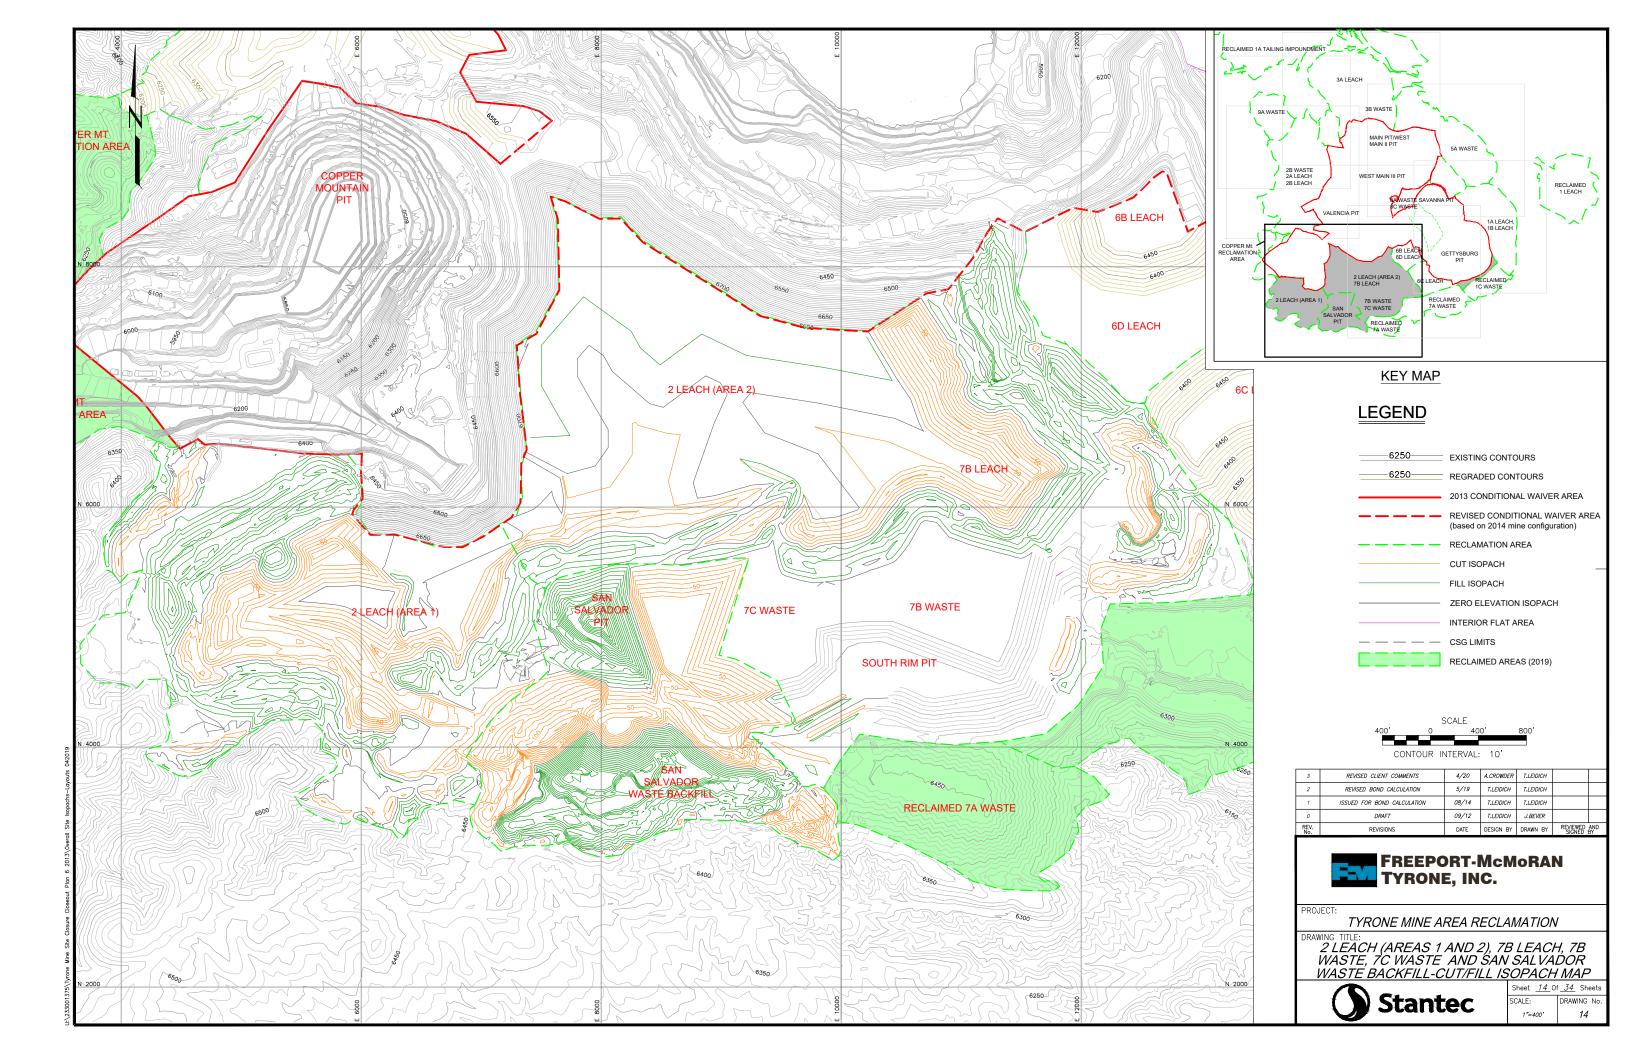


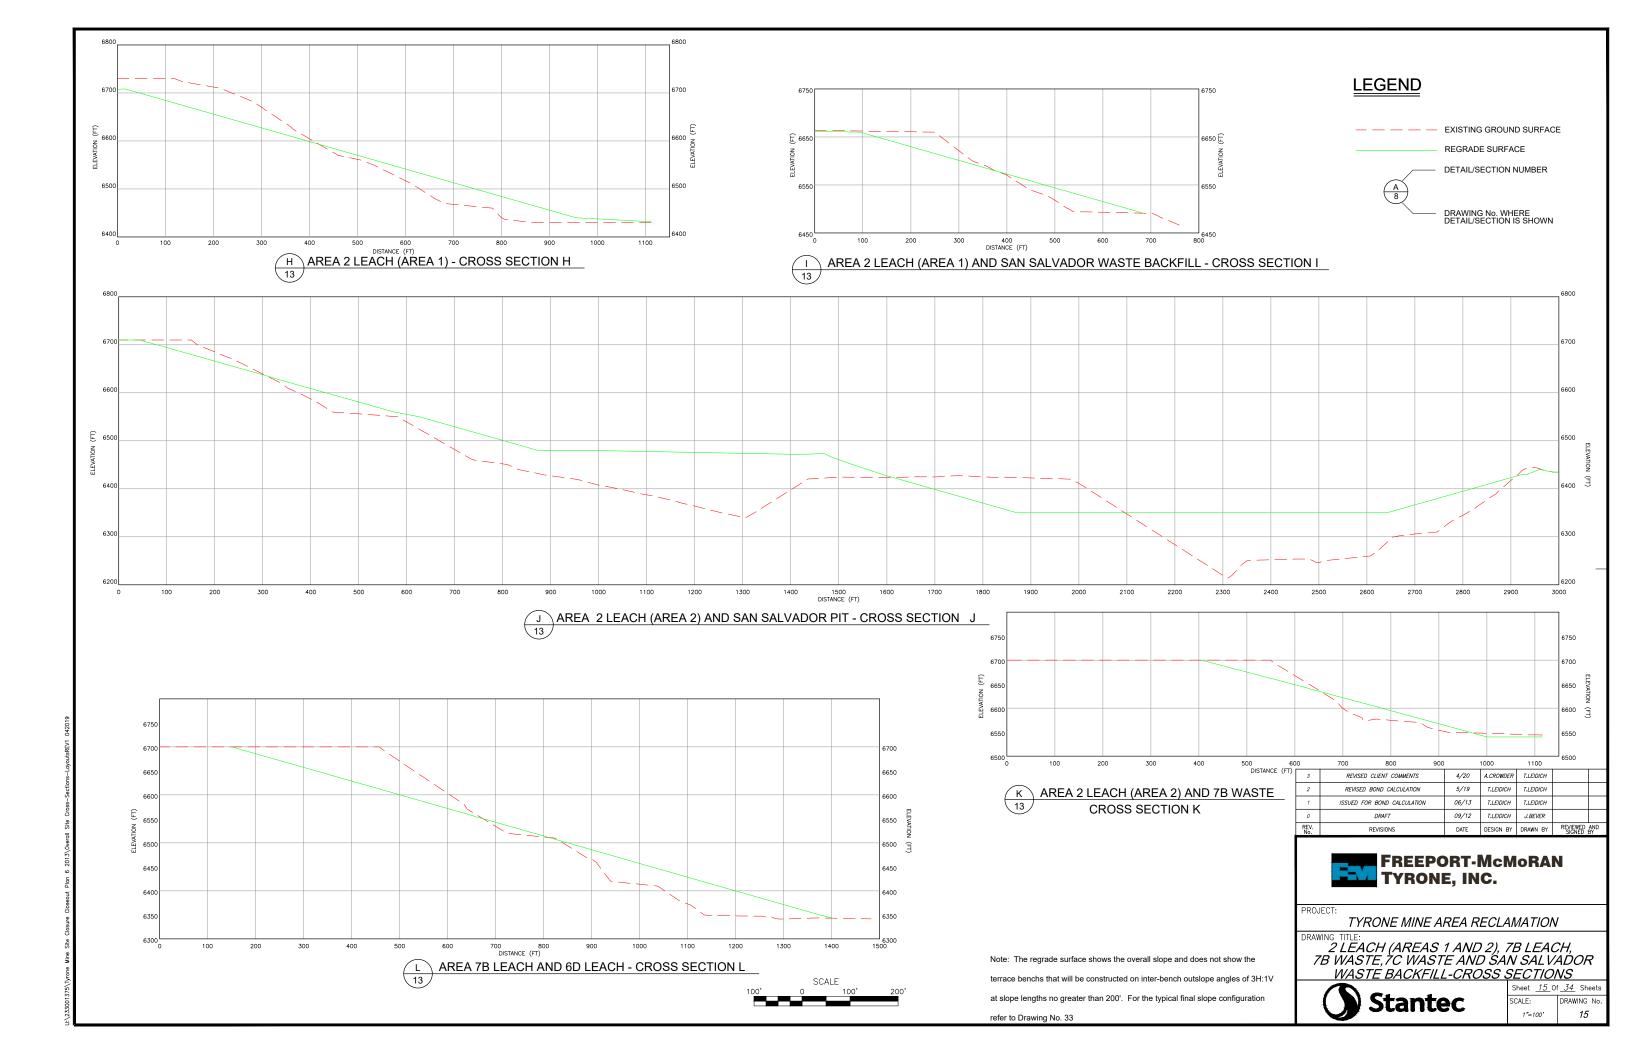


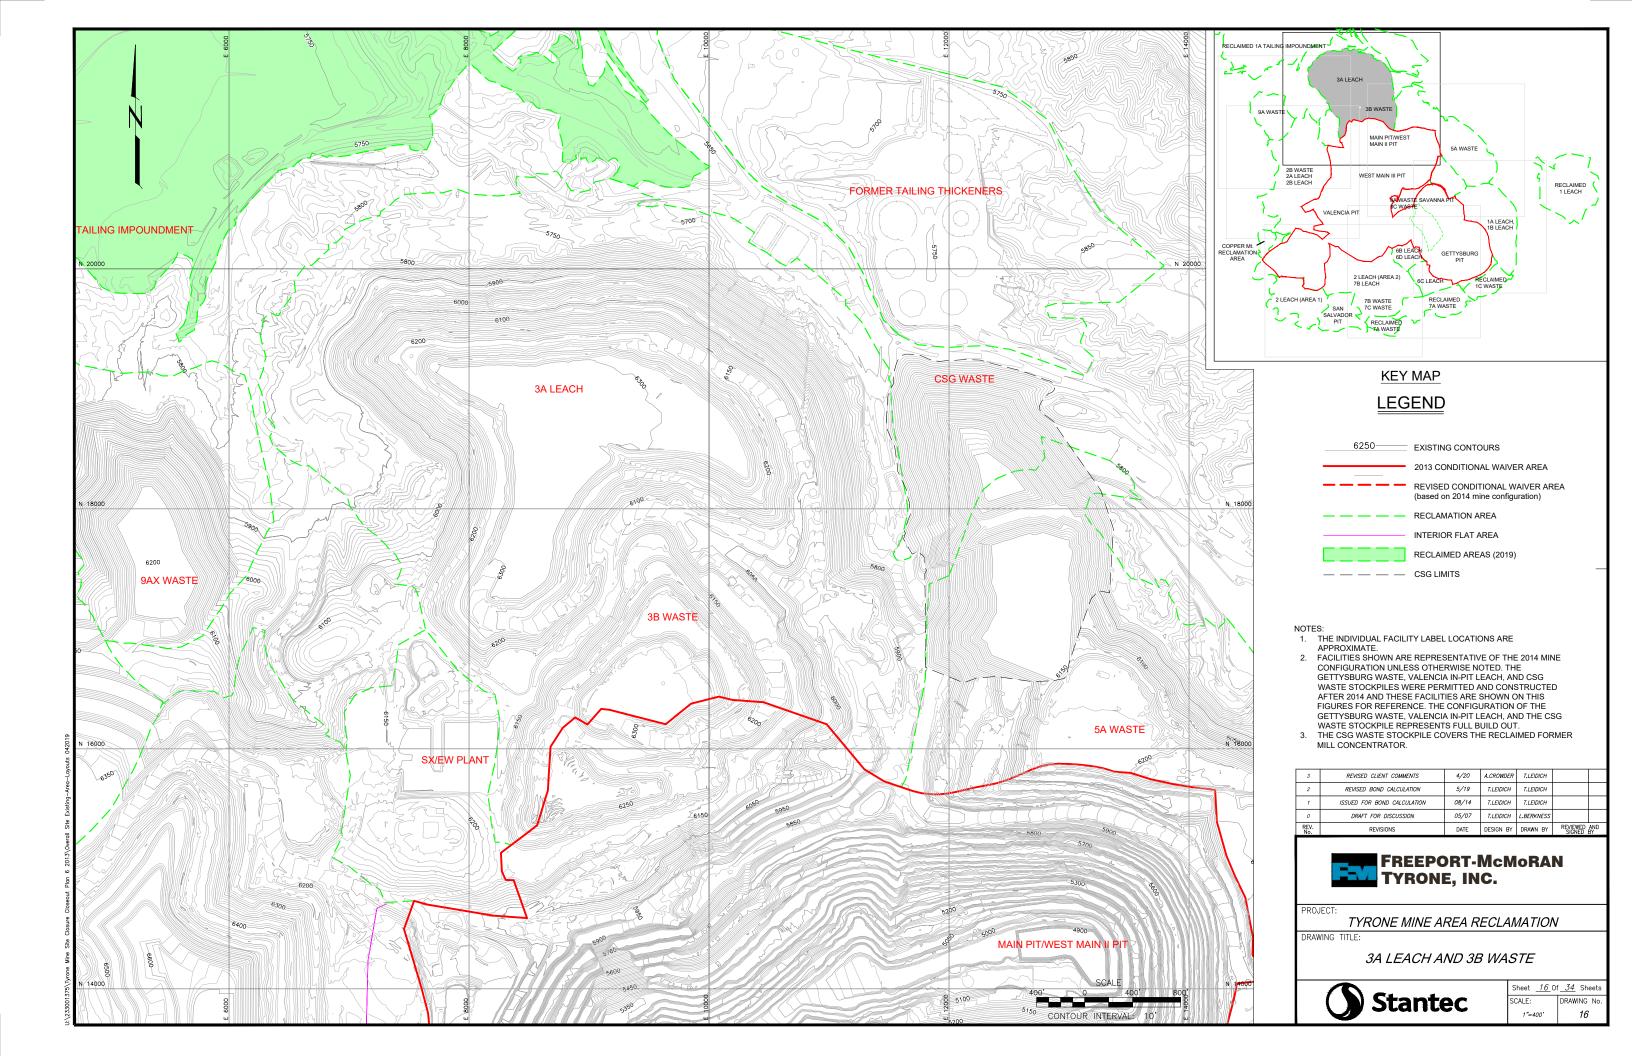

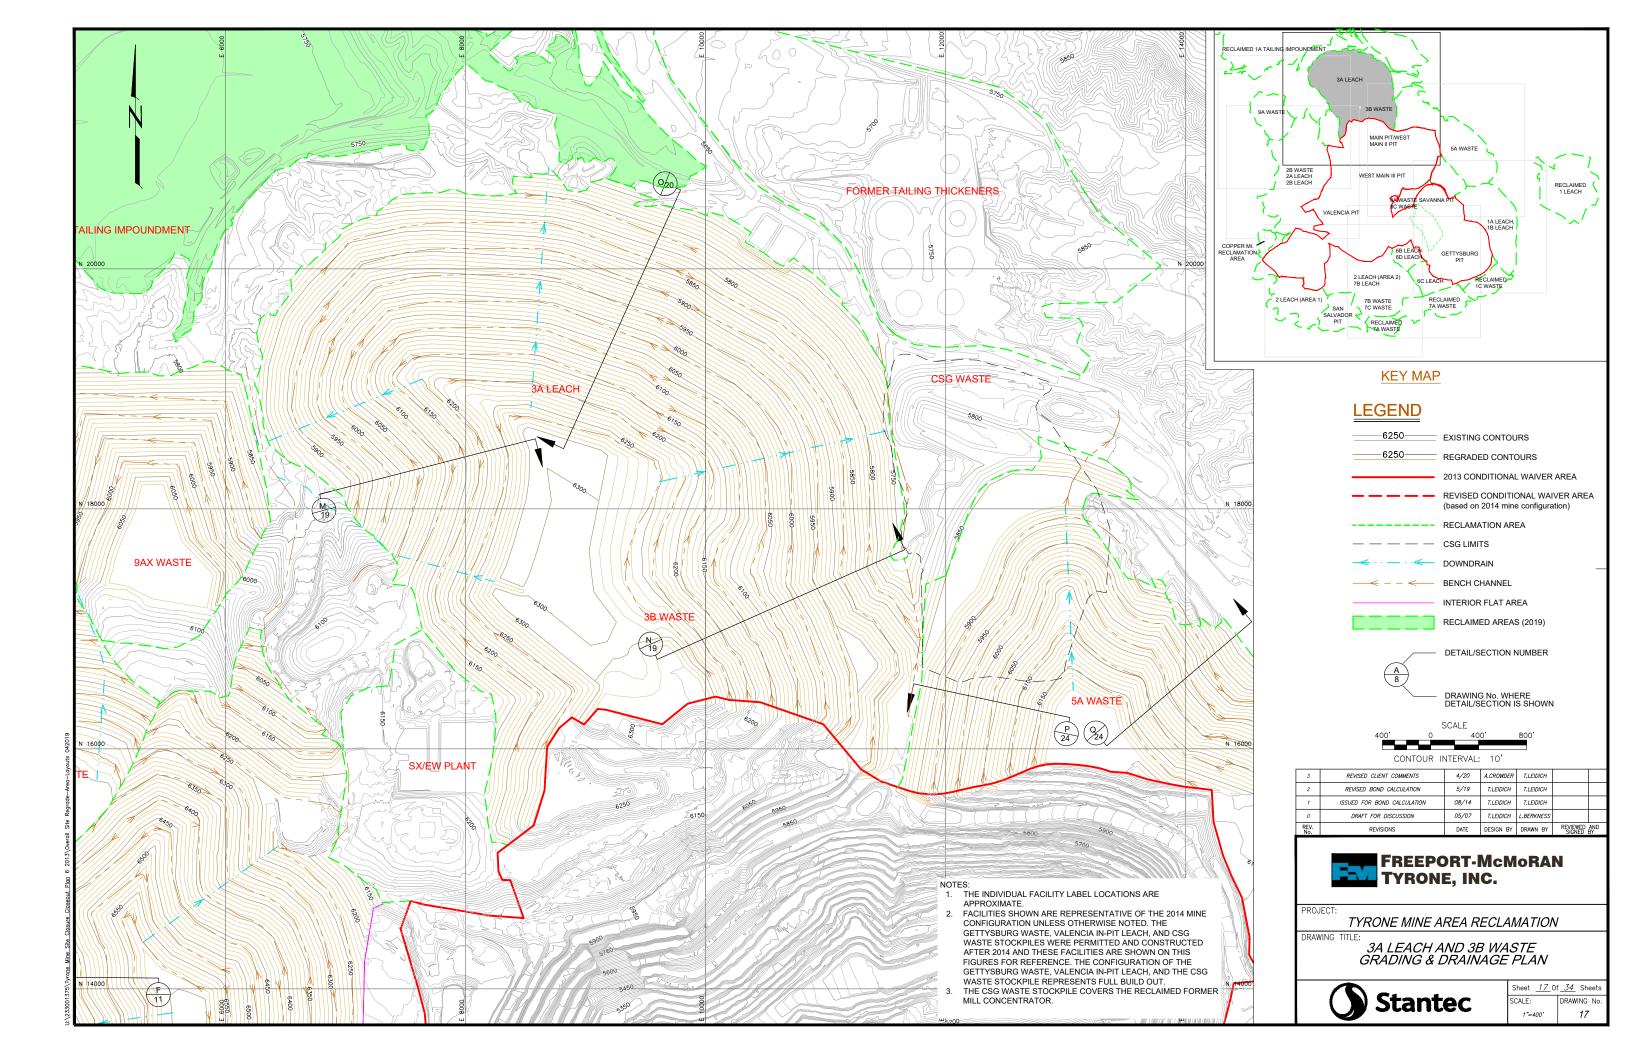

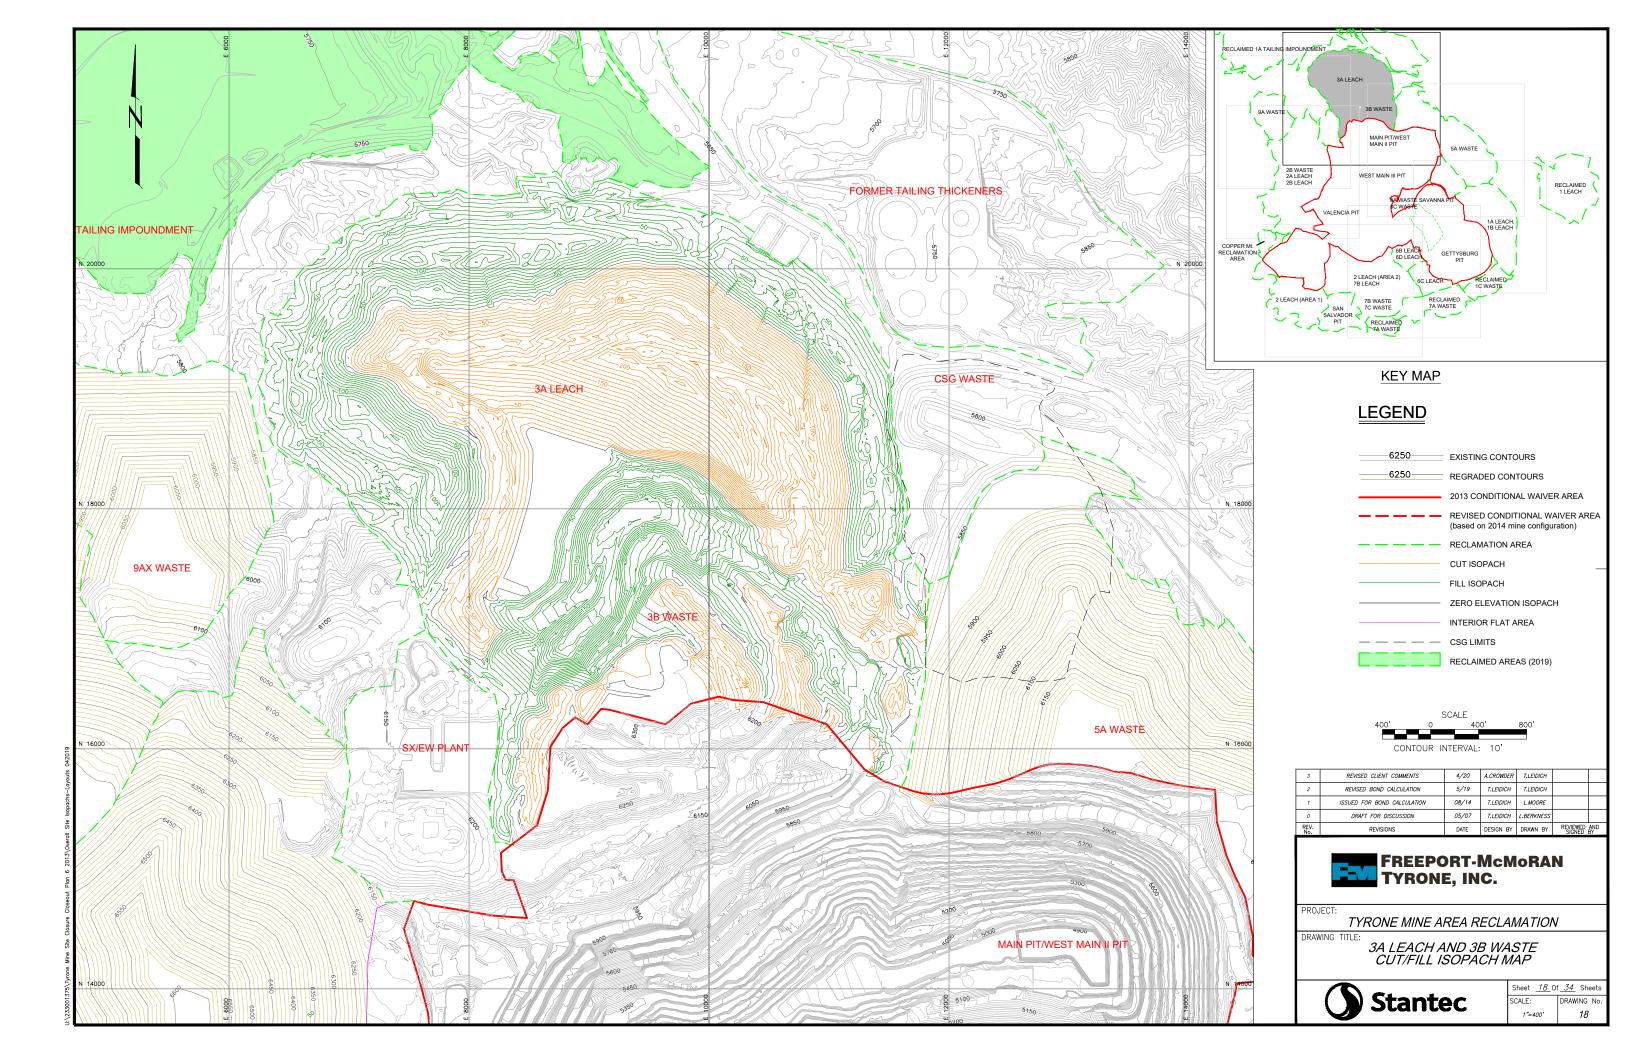

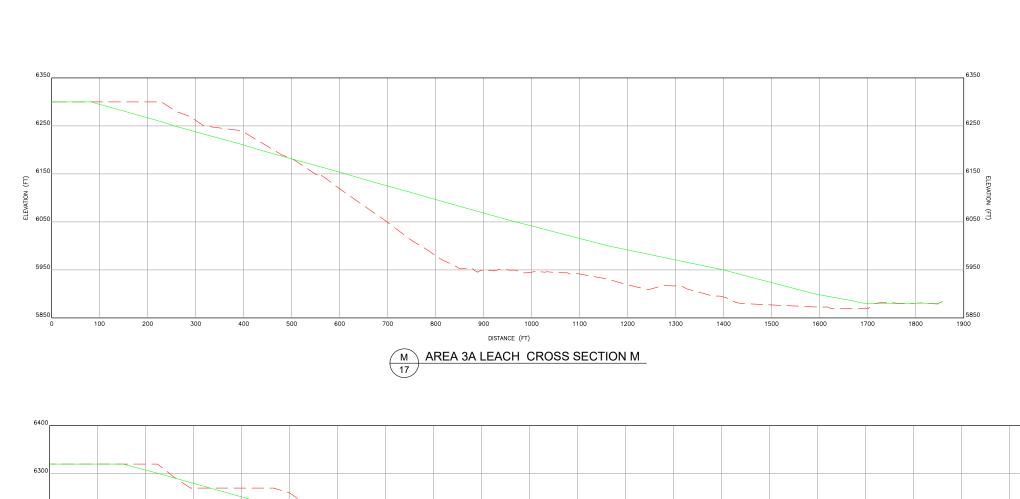

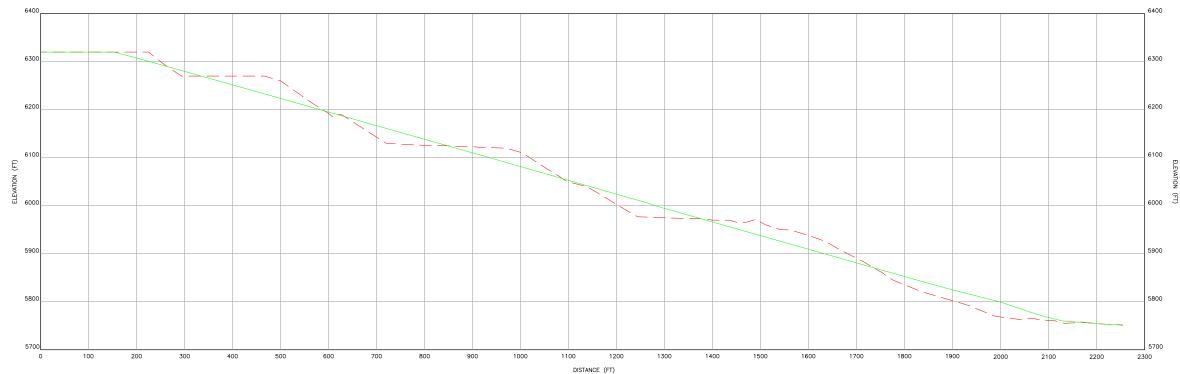

N AREA 3B WASTE CROSS SECTION N

Note: The regrade surface shows the overall slope and does not show the terrace benchs that will be constructed on inter-bench outslope angles of 3H:1V at slope lengths no greater than 200'. For the typical final slope configuration refer to Drawing No. 33

## LEGEND

EXISTING GROUND SURFACE

REGRADE SURFACE

DETAIL/SECTION NUMBER

B

DRAWING No. WHERE DETAIL/SECTION IS SHOWN

SCALE 100' 0 100' 200'

3	REVISED CLIENT COMMENTS	4/20	A.CROWDER	T.LEIDICH	
2	REVISED BOND CALCULATION	5/19	T.LEIDICH	T.LEIDICH	
1	ISSUED FOR BOND CALCULATION	06/13	T.LEIDICH	T.LEIDICH	
0	DRAFT	09/12	T.LEIDICH	J.BEVER	
REV. No.	REVISIONS	DATE	DESIGN BY	DRAWN BY	REVIEWED AND SIGNED BY



PROJECT:

TYRONE MINE AREA RECLAMATION

DRAWING TITLE:

3A LEACH AND 3B WASTE

CROSS SECTIONS - 1



 Sheet
 19 Of
 34 OF
 Sheets


 SCALE:
 DRAWING No.
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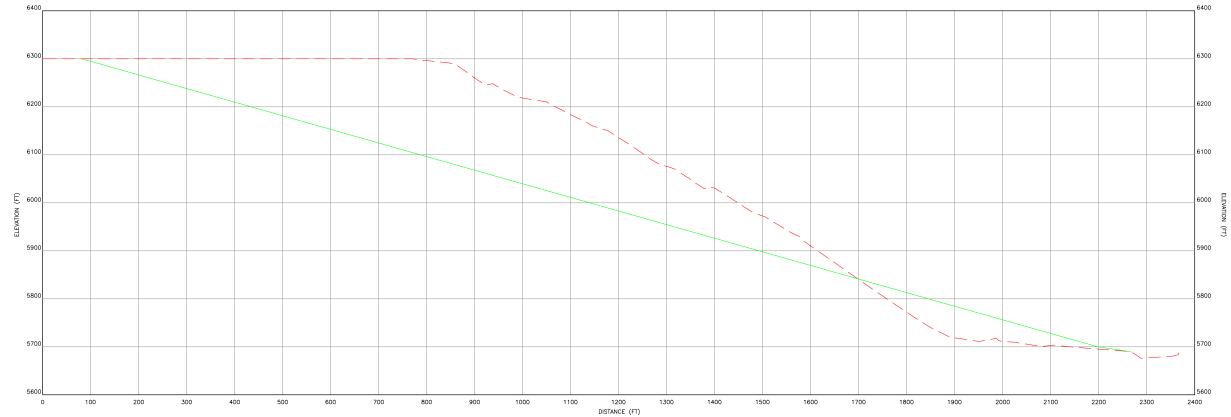
# <u>LEGEND</u>

---- EXISTING GROUND SURFACE REGRADE SURFACE

DETAIL/SECTION NUMBER

DRAWING No. WHERE DETAIL/SECTION IS SHOWN



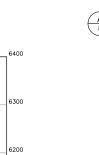

0 AREA 3A LEACH CROSS SECTION 0

				,		
3	REVISED CLIENT COMMENTS	4/20	A.CROWDER	T.LEIDICH		
2	REVISED BOND CALCULATION	5/19	T.LEIDICH	T.LEIDICH		
1	ISSUED FOR BOND CALCULATION	06/13	T.LEIDICH	T.LEIDICH		
0	DRAFT	09/12	T.LEIDICH	J.BEVER		
REV. No.	REVISIONS	DATE	DESIGN BY	DRAWN BY	REVIEWED AN SIGNED BY	ID



PROJECT:

Note: The regrade surface shows the overall slope and does not show the terrace benchs that will be constructed on inter-bench outslope angles of 3H:1V at slope lengths no greater than 200'. For the typical final slope configuration


refer to Drawing No. 33


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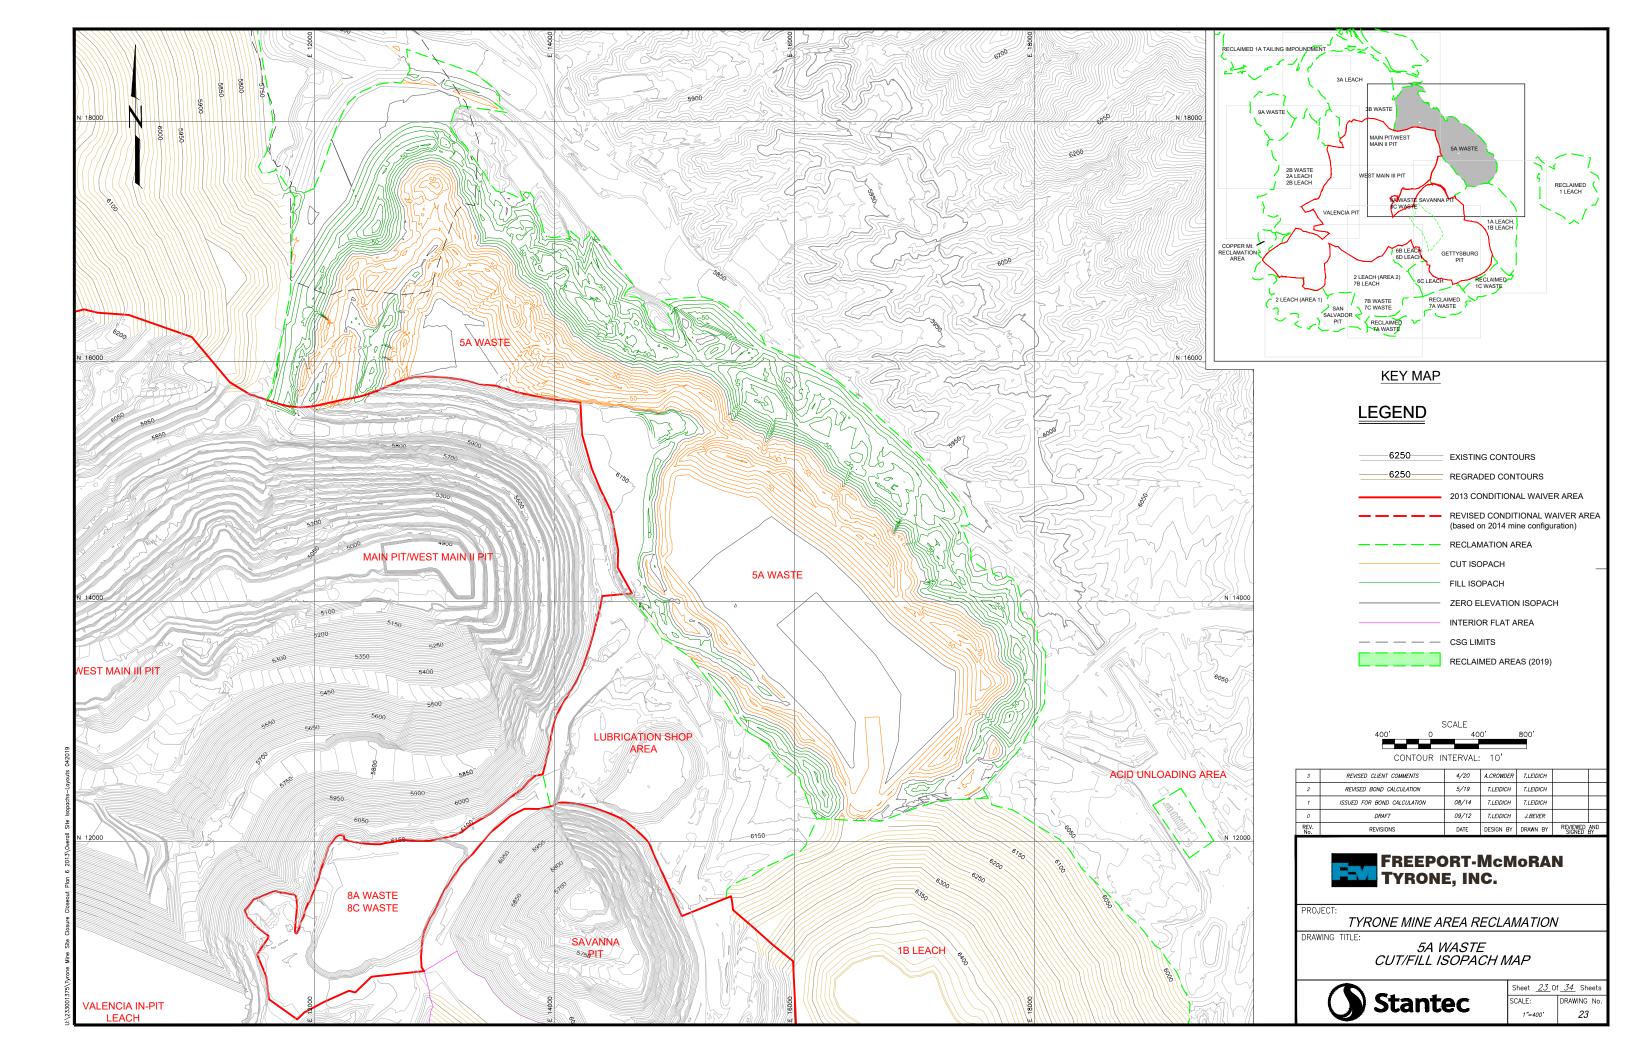
3A LEACH AND 3B WASTE CROSS SECTIONS - 2




	Sheet <u>20</u> 0f <u>34</u> Sheet				
Stantec	SCALE: 1"=100'	DRAWING N			



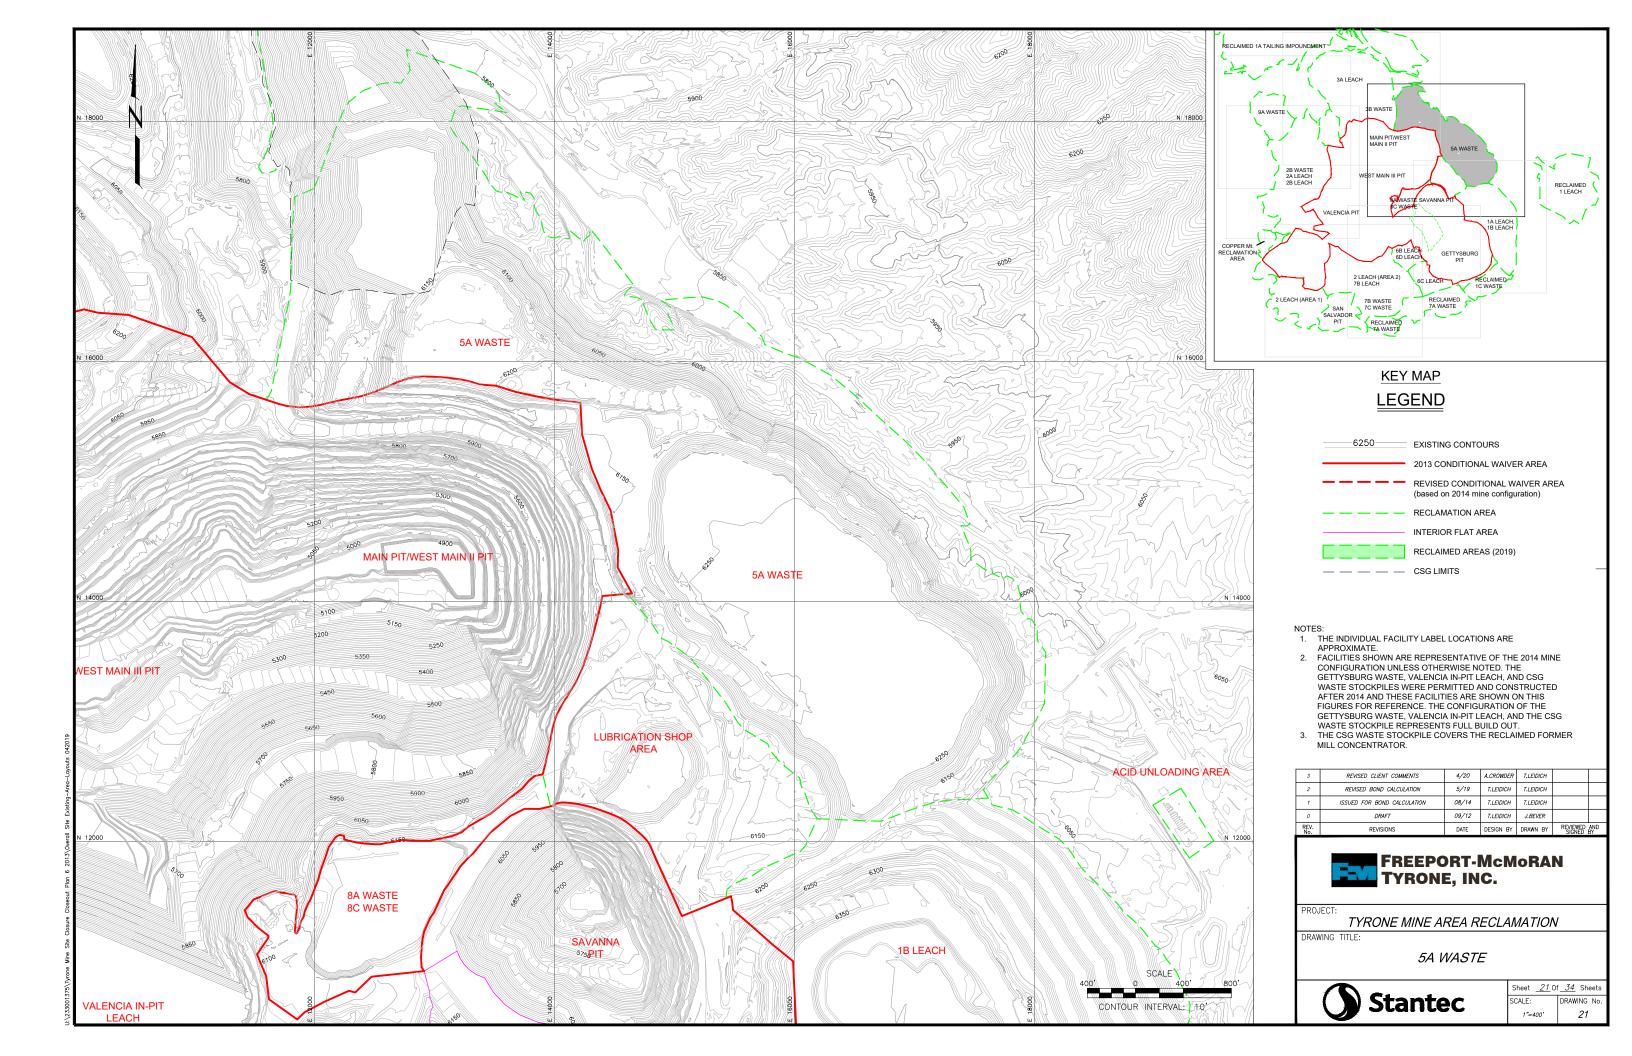

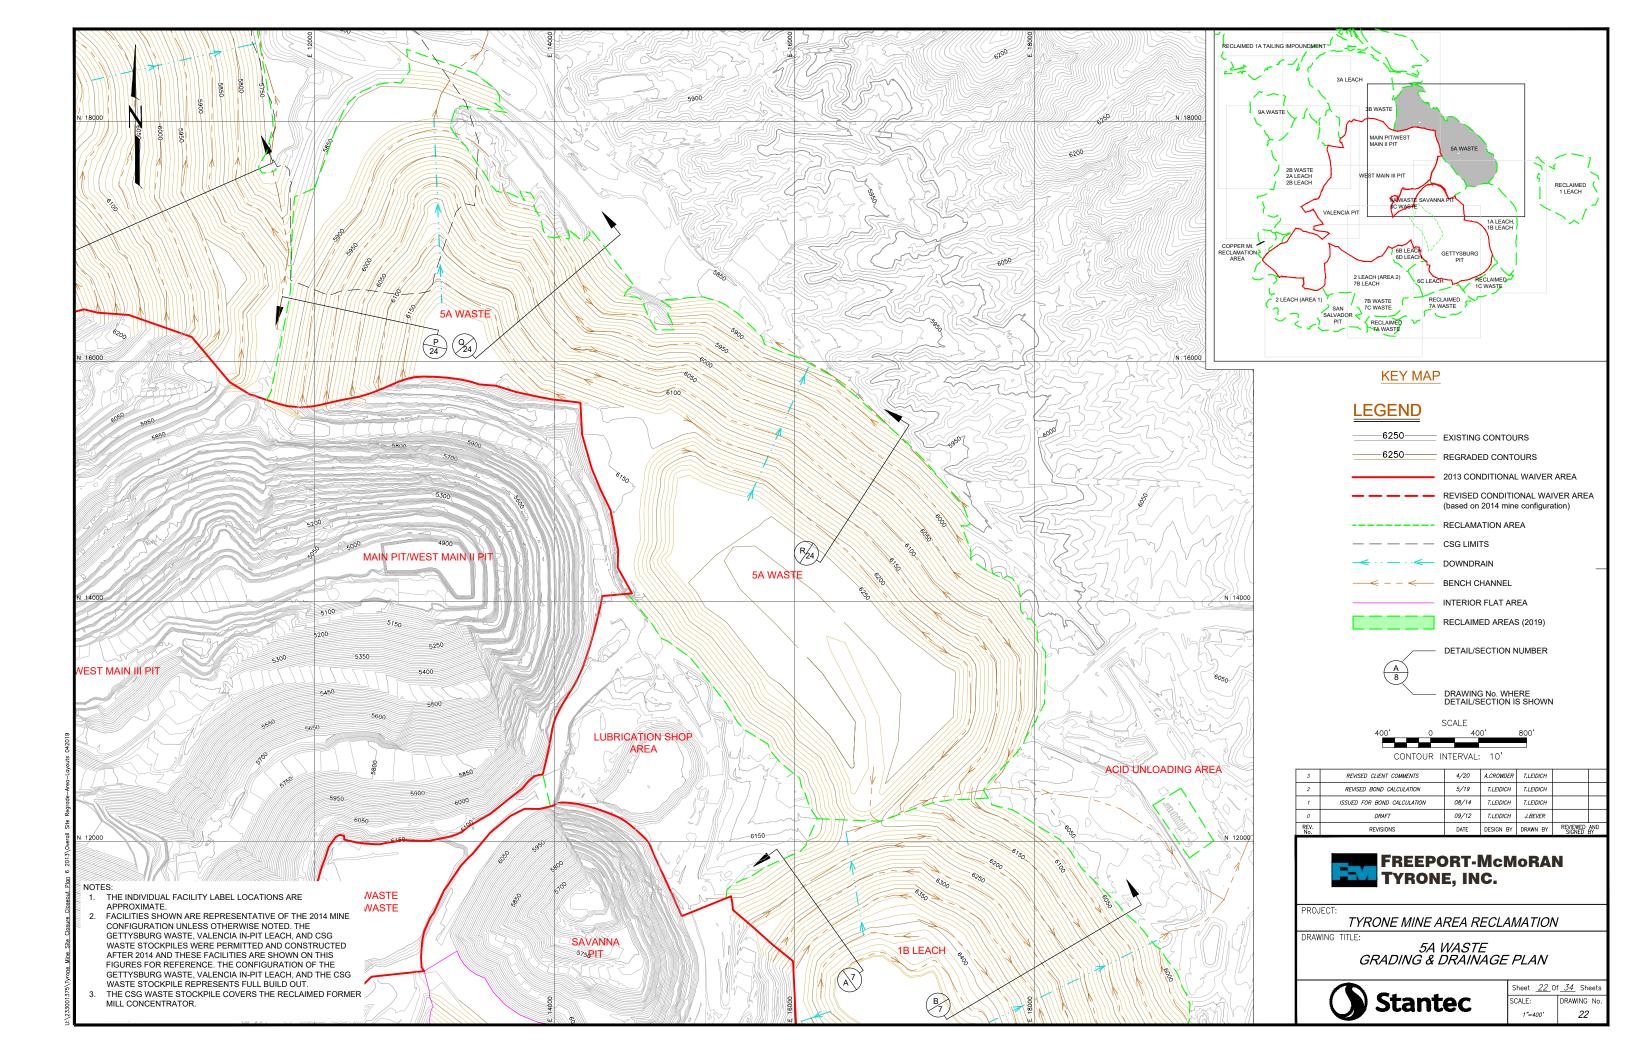

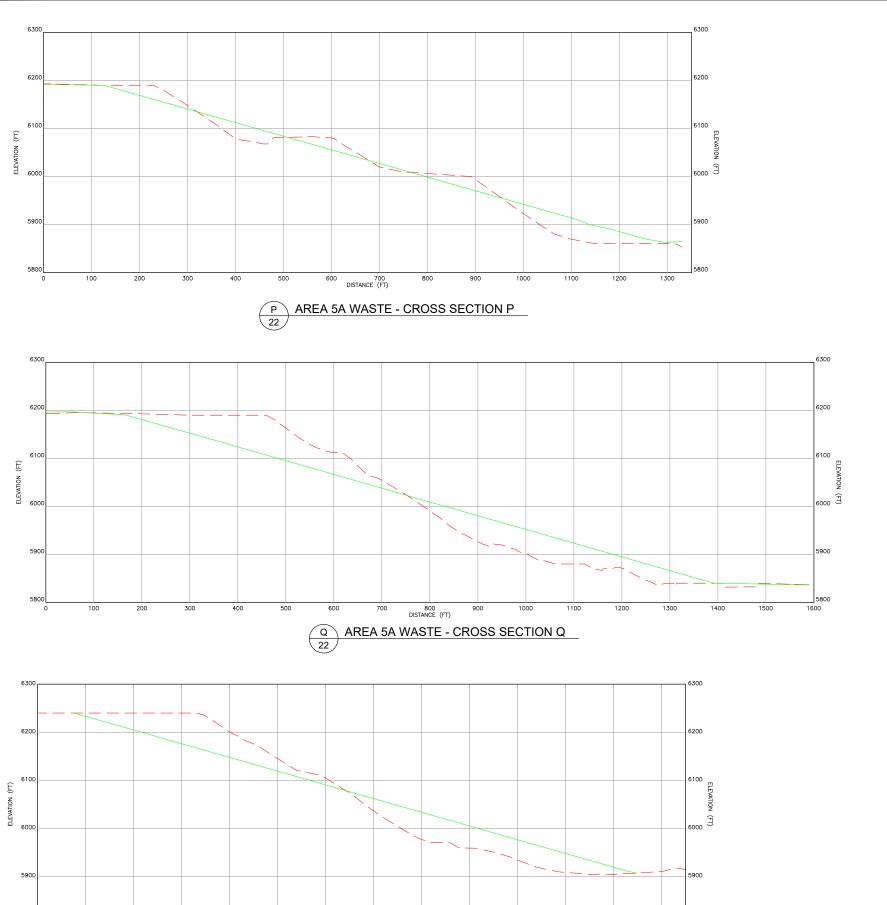

R AREA 5A WASTE- CROSS SECTION R

Note: The regrade surface shows the overall slope and does not show the terrace benchs that will be constructed on inter-bench outslope angles of 3H:1V at slope lengths no greater than 200'. For the typical final slope configuration refer to Drawing No. 33


## **LEGEND**

EXISTING GROUND SURFACE

REGRADE SURFACE

DETAIL/SECTION NUMBER

DRAWING No. WHERE DETAIL/SECTION IS SHOWN

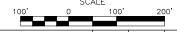

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2	REVISED BOND CALCULATION	5/19	T.LEIDICH	T.LEIDICH		
1	ISSUED FOR BOND CALCULATION	06/13	T.LEIDICH	T.LEIDICH		
0	DRAFT	09/12	T.LEIDICH	J.BEVER		
REV. No.	REVISIONS	DATE	DESIGN BY	DRAWN BY	REVIEWED / SIGNED E	AND BY



PROJECT:

TYRONE MINE AREA RECLAMATION

DRAWING TITLE:


*5A WASTE* CROSS SECTIONS




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 24 Of
 34 Sheets

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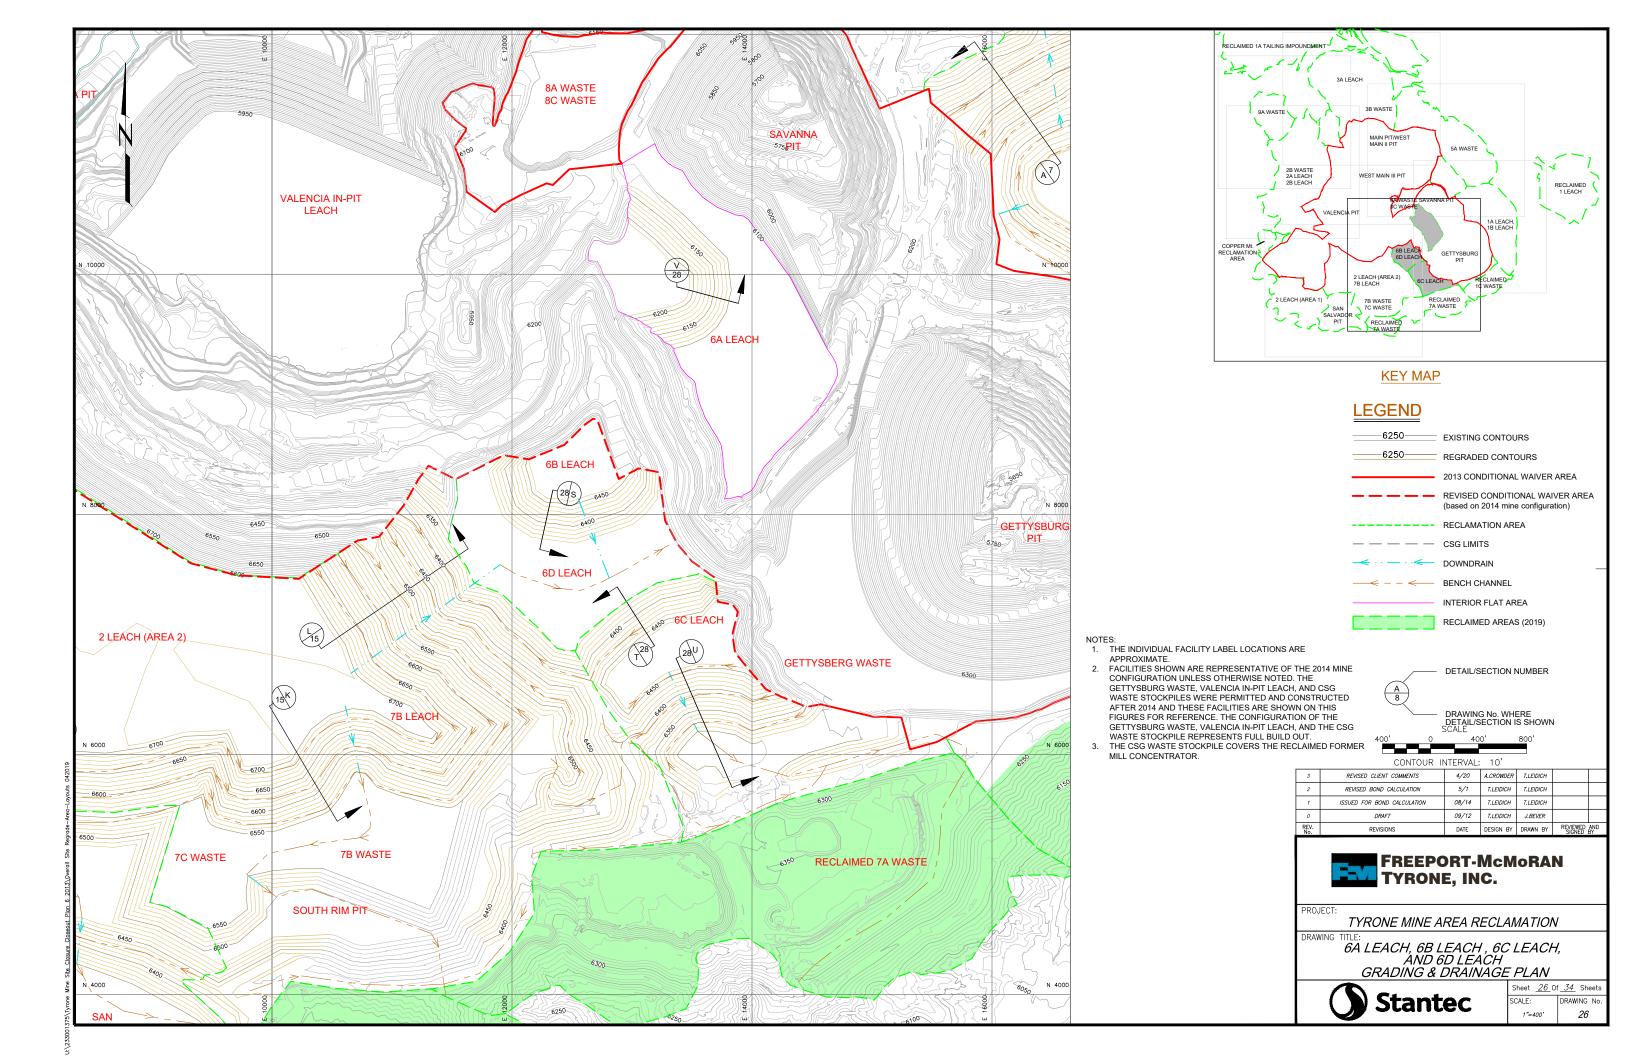
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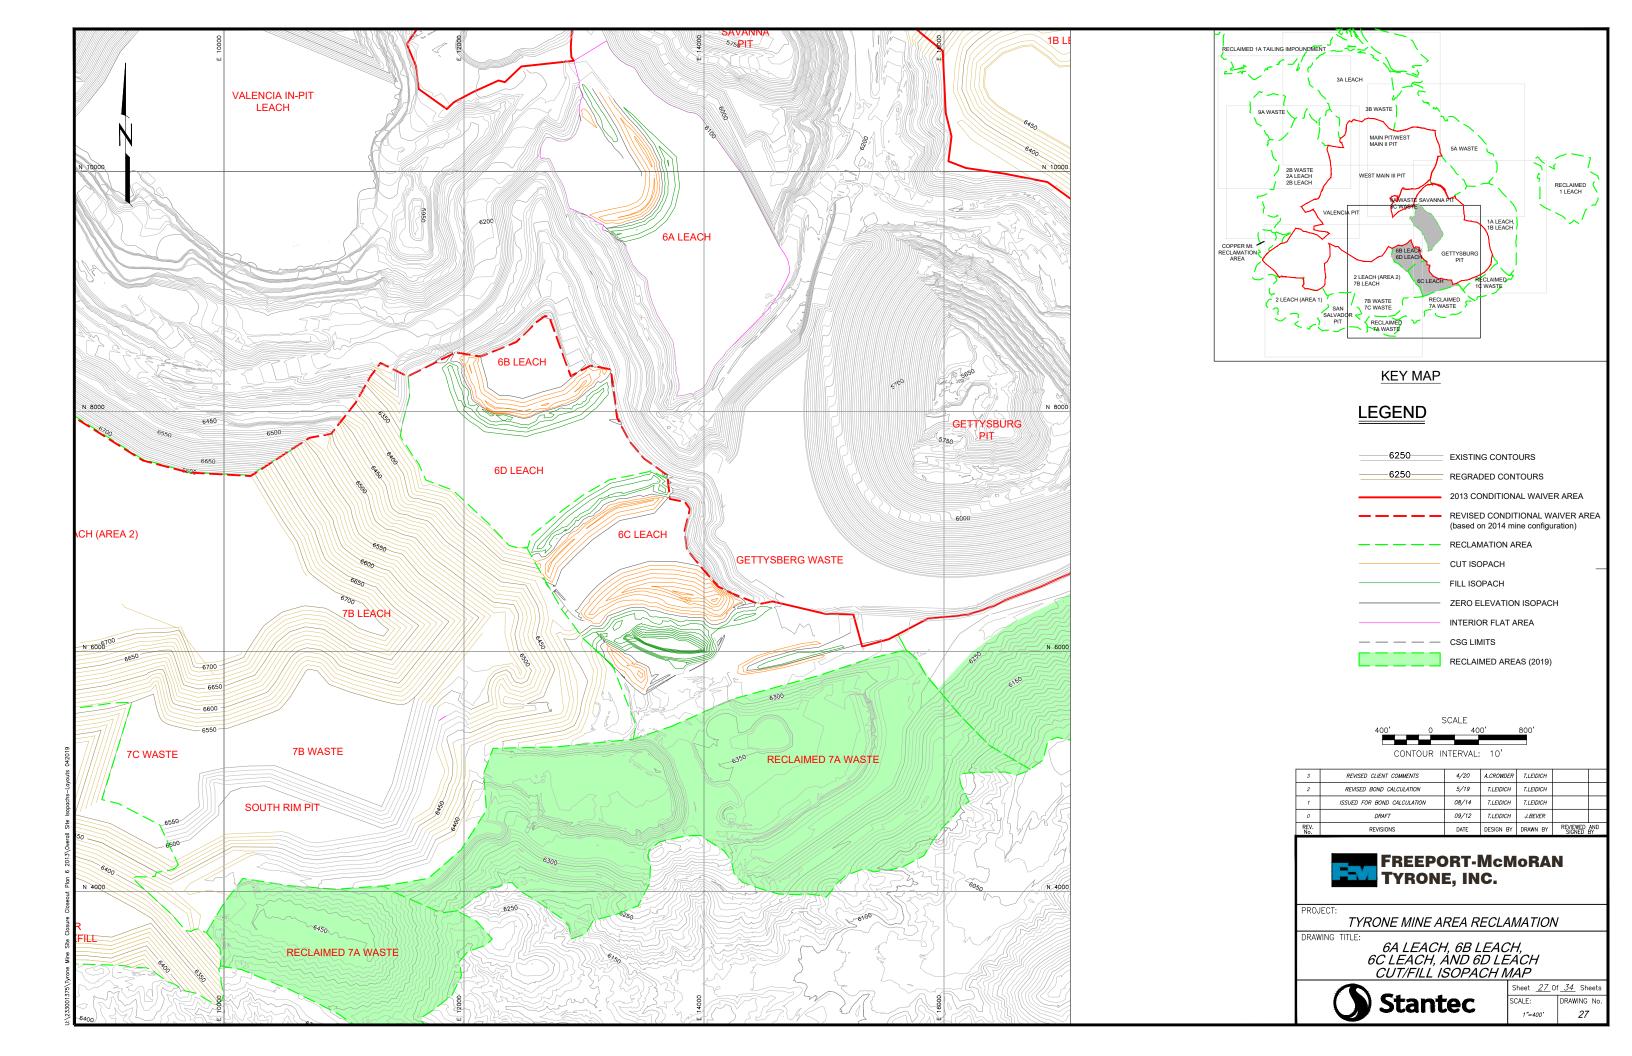


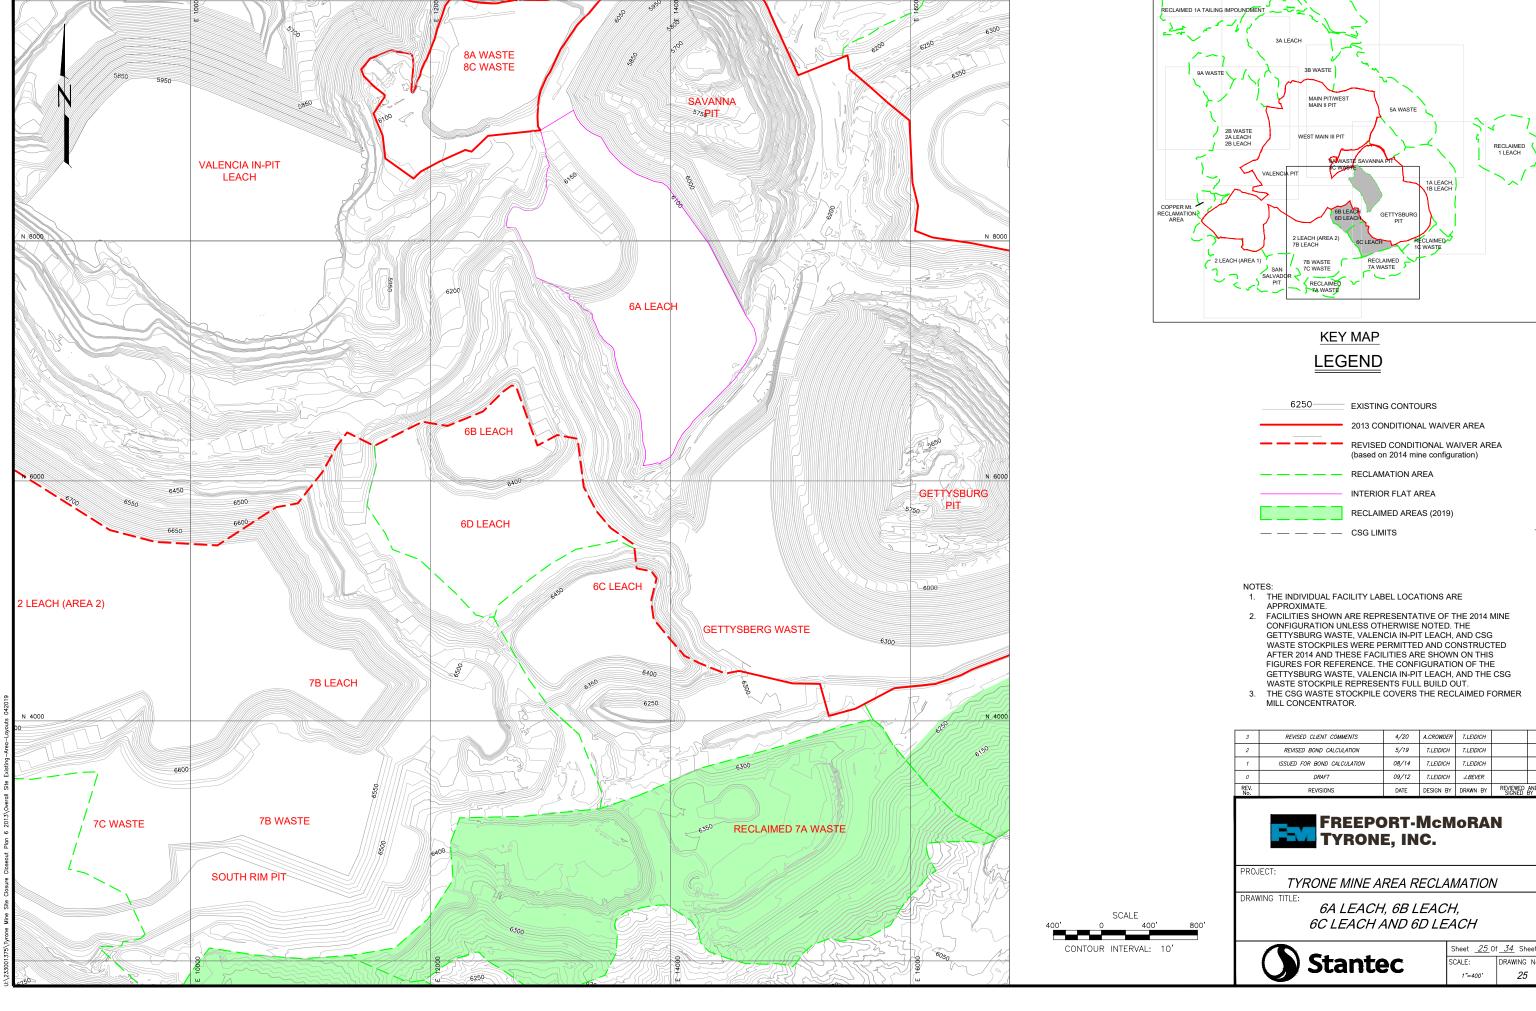



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2	REVISED BOND CALCULATION	5/19	T.LEIDICH	T.LEIDICH		
1	ISSUED FOR BOND CALCULATION	08/14	T.LEIDICH	T.LEIDICH		
0	DRAFT	09/12	T.LEIDICH	J.BEVER		
REV.	REVISIONS	DATE	DESIGN BY	DRAWN BY	REVIEWED A	'nD

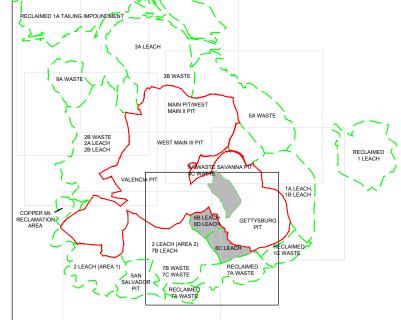
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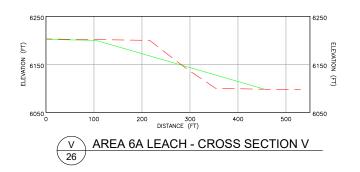






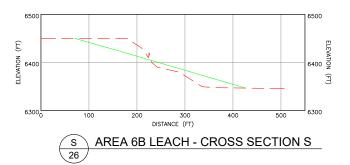

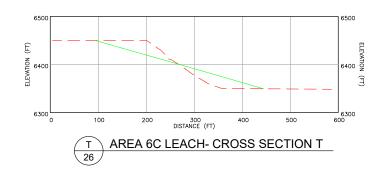

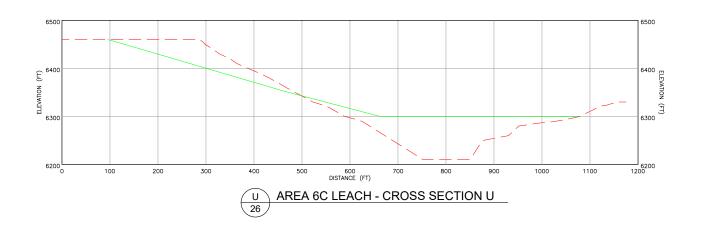

Note: The regrade surface shows the overall slope and does not show the terrace benchs that will be constructed on inter-bench outslope angles of 3H:1V at slope lengths no greater than 200'. For the typical final slope configuration refer to Drawing No. 33

## **LEGEND**

— — — — EXISTING GROUND SURFACE REGRADE SURFACE DETAIL/SECTION NUMBER DRAWING No. WHERE DETAIL/SECTION IS SHOWN



3	REVISED CLIENT COMMENTS	4/20	A.CROWDER	T.LEIDICH		
2	REVISED BOND CALCULATION	5/19	T. LEIDICH	T. LEIDICH		
1	ISSUED FOR BOND CALCULATION	06/13	T.LEIDICH	T.LEIDICH		
0	DRAFT	09/12	T.LEIDICH	J.BEVER		
REV. No.	REVISIONS	DATE	DESIGN BY	DRAWN BY	REVIEWED . SIGNED E	AND 3Y




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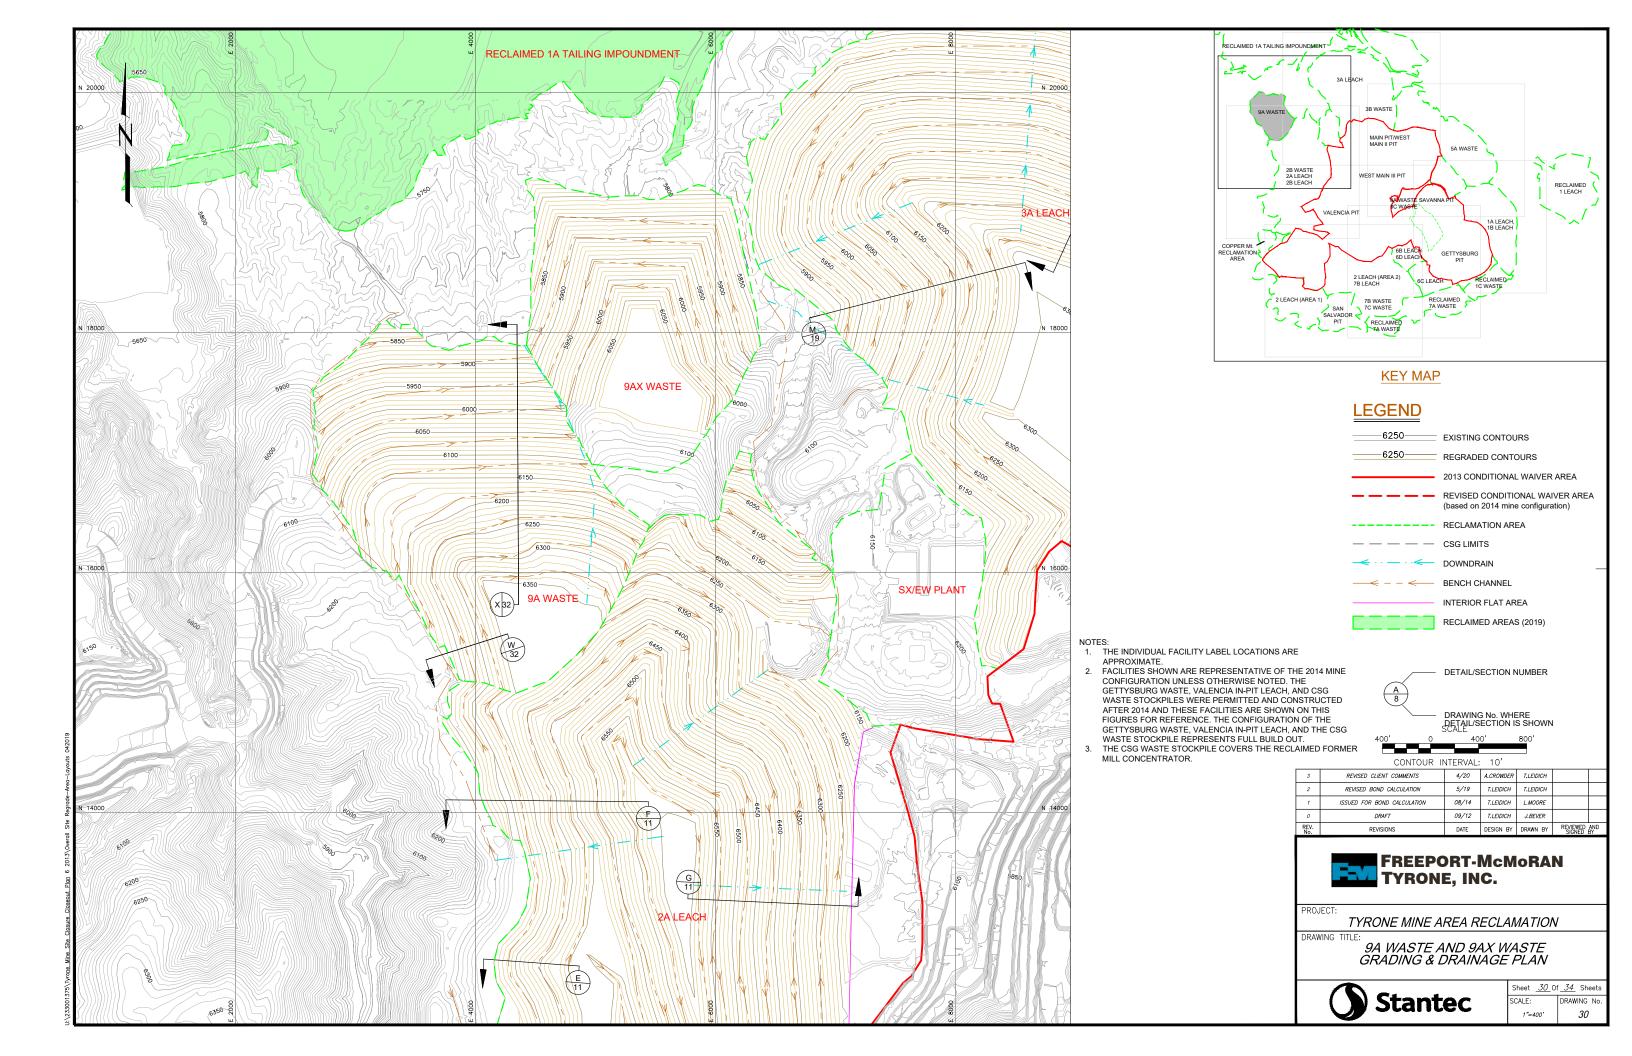
TYRONE MINE AREA RECLAMATION


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AND 6D LEACH - CROSS SECTIONS




Sheet <u>28</u> Of <u>34</u> Sheets SCALE: DRAWING No. 1"=100' 28




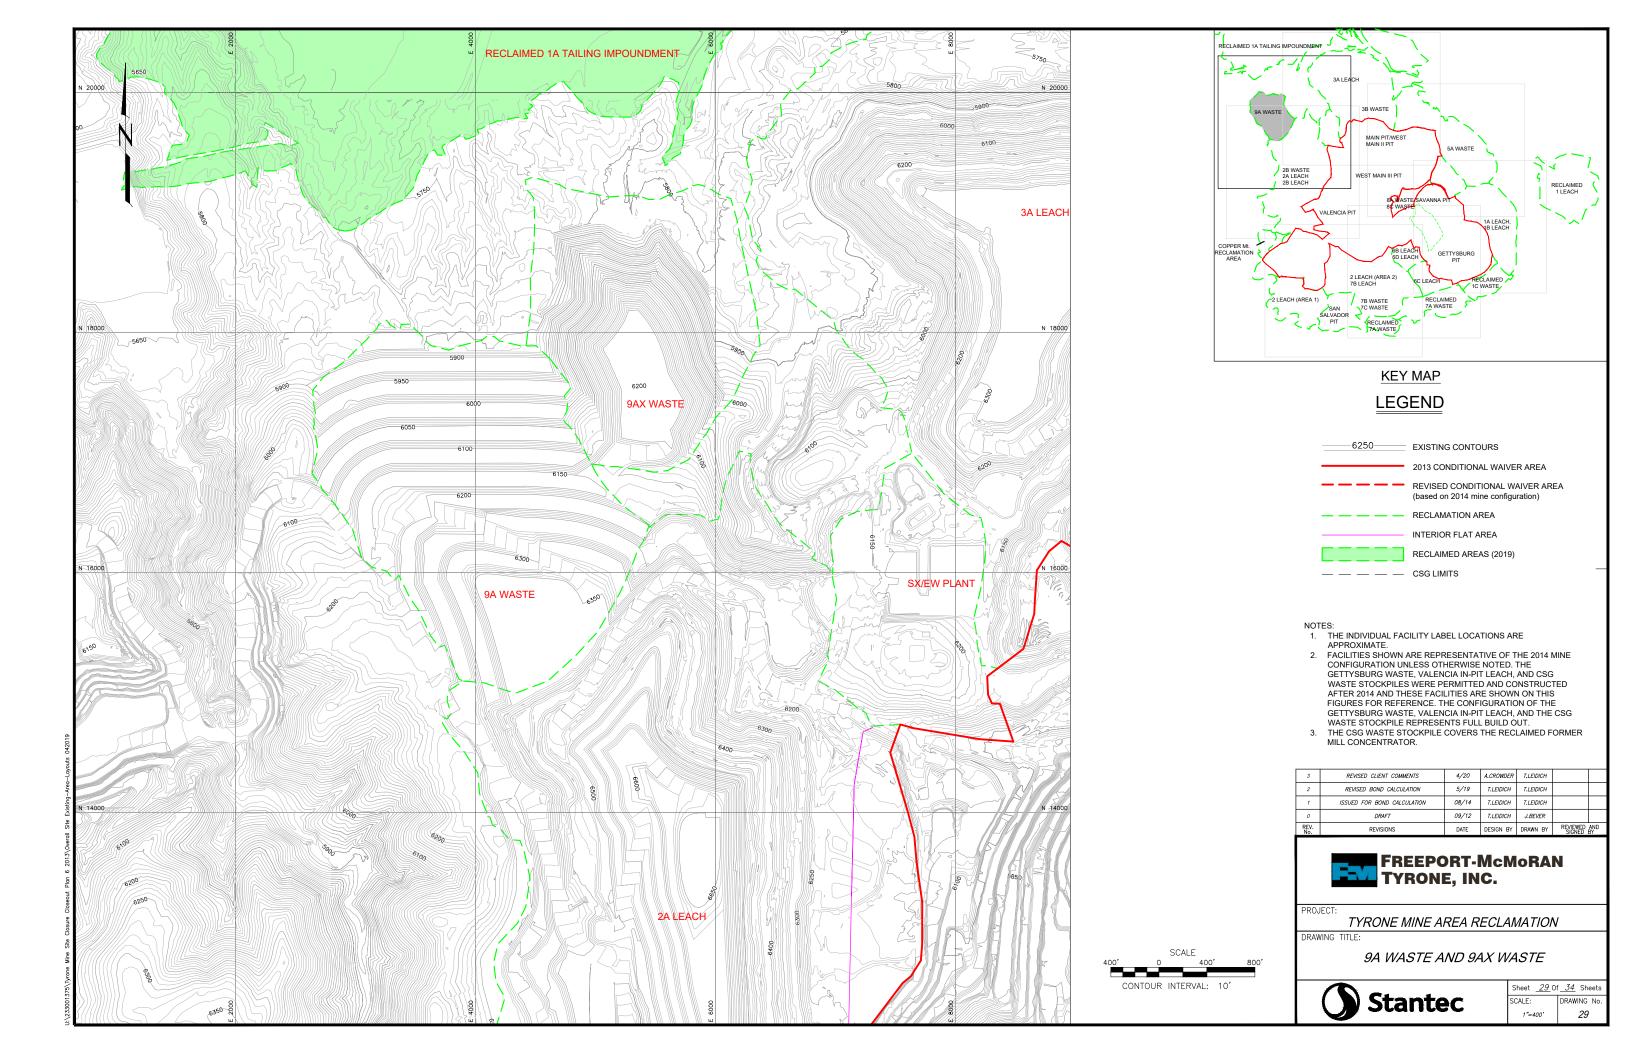

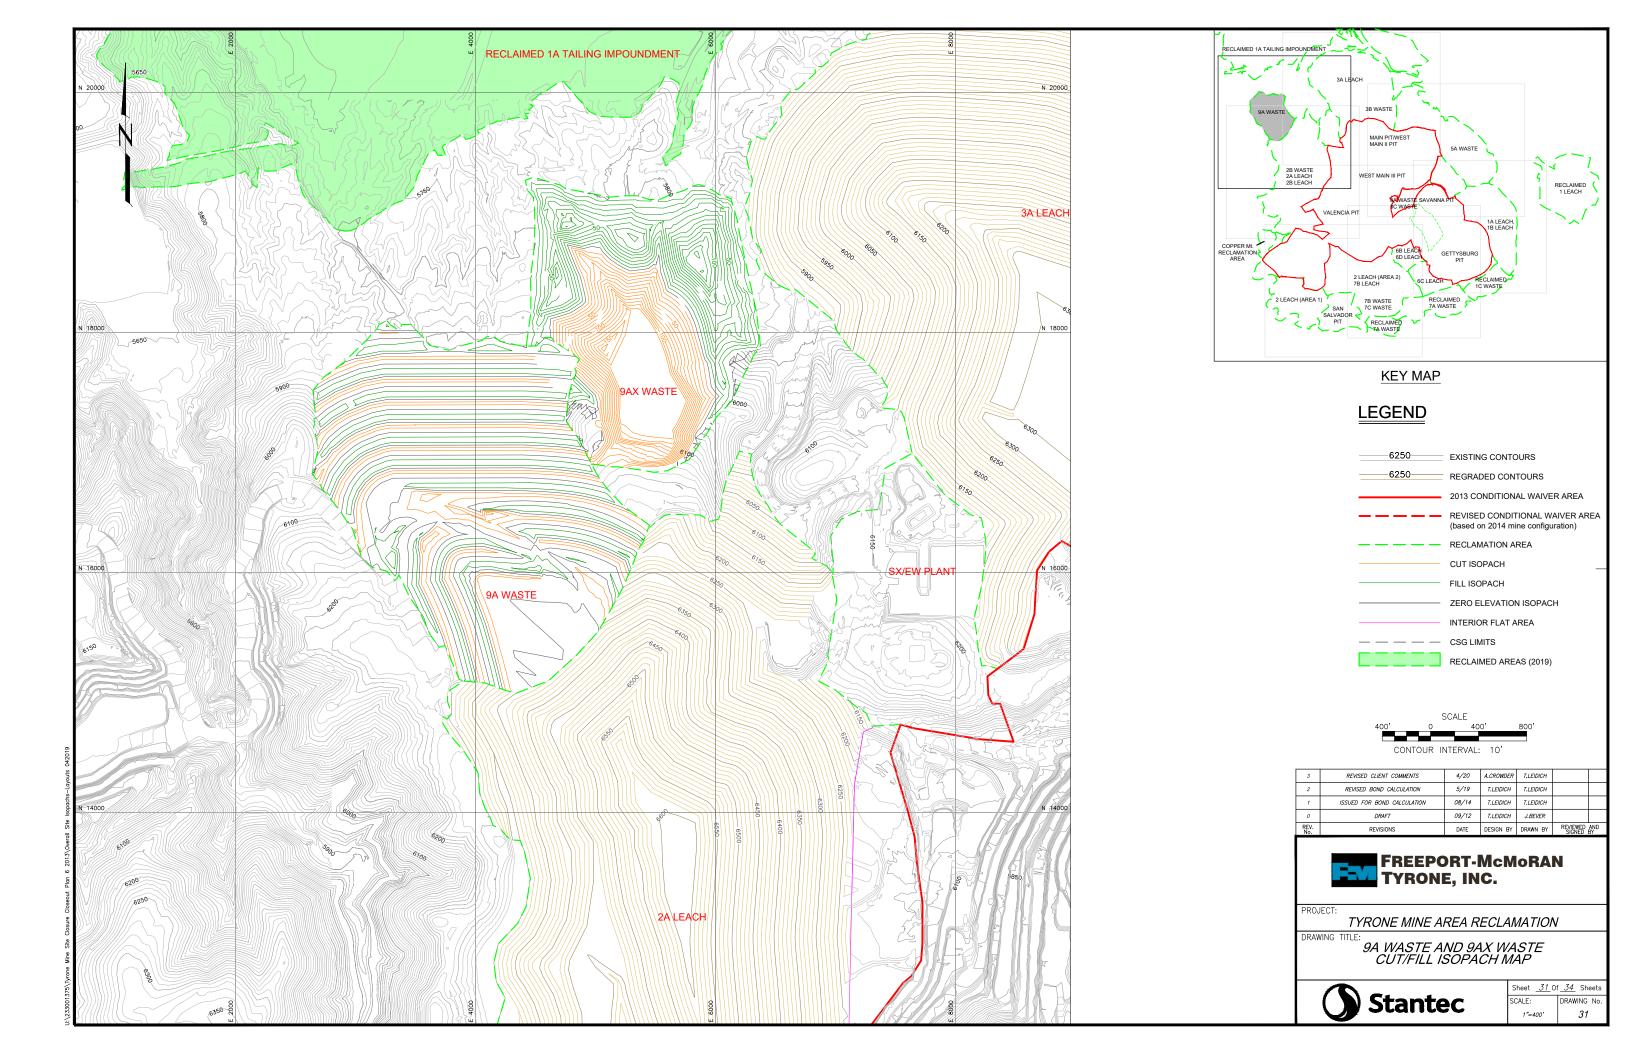

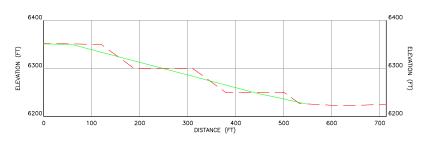

W AREA 9A WASTE - CROSS SECTION W

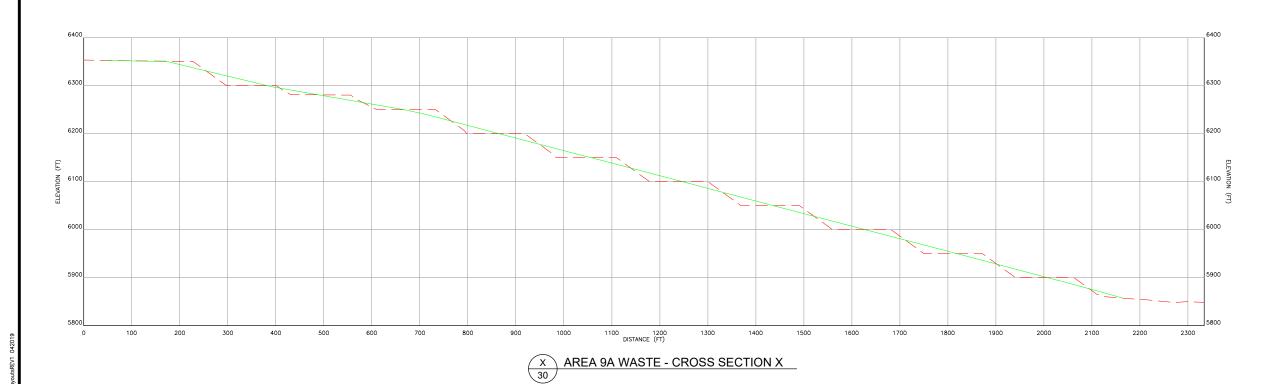

#### Notes:

- The regrade surface shows the overall slope and does not show the terrace benchs that will be constructed on inter-bench outslope angles of 3H:1V at slope lengths no greater than 200'. For the typical final slope configuration refer to Drawing No. 33
- For Cross Sections of the 9AX Waste Stockpile, see Figure 5 to Modification 14-1 to Permit GR010RE

## LEGEND

REGRADE SURFACE

DETAIL/SECTION NUMBER

DRAWING No. WHERE DETAIL/SECTION IS SHOWN



3	REVISED CLIENT COMMENTS	4/20	A.CROWDER	T.LEIDICH	
2	REVISED BOND CALCULATION	5/19	T.LEIDICH	T.LEIDICH	
1	ISSUED FOR BOND CALCULATION	06/13	T. LEIDICH	T.LEIDICH	
0	DRAFT	09/12	T.LEIDICH	J.BEVER	
REV. No.	REVISIONS	DATE	DESIGN BY	DRAWN BY	REVIEWED AND SIGNED BY



PROJECT:

TYRONE MINE AREA RECLAMATION

DRAWING TITLE:


9A WASTE AND 9AX WASTE - CROSS SECTIONS




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 32 Of
 34 Sheets

 SCALE:
 DRAWING No.


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# TYPICAL BENCH CHANNEL CROSS SECTION

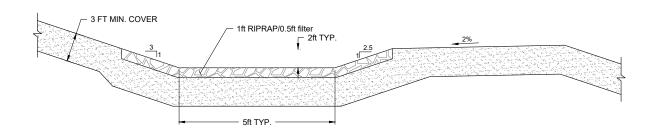


TYPICAL DOWNDRAIN CHANNEL CROSS SECTION

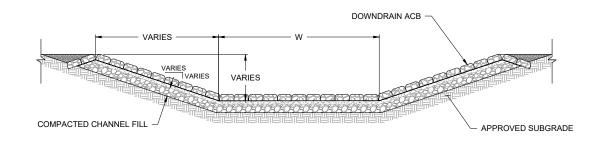


### TYPICAL SLOPE CONFIGURATION

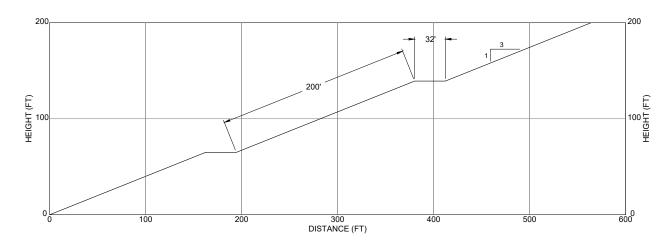

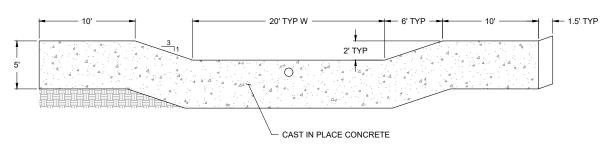

### TYPICAL CUTOFF WALL SECTION



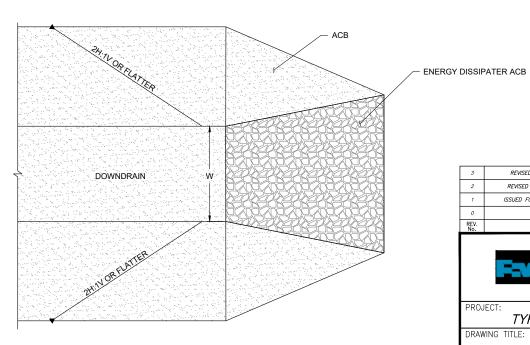

TYPICAL TOE ENERGY DISSIPATOR PLAN DETAIL

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2	REVISED BOND CALCULATIONS	5/19	T.Leidich	T.Leidich		
1	ISSUED FOR BOND CALCULATION	06/13	T.Liedich	T Leidich		
0	-DRAFT	09/12	T.Liedich	J.Bever		
REV.	REVISIONS	DATE	DESIGN BY	DRAWN BY	REVIEWED SIGNED	AND BY



TYRONE MINE AREA RECLAMATION

DRAWING TITLE:

DRAINAGE DETAILS



Sheet <u>33</u> Of <u>34</u> Sheets SCALE: DRAWING No. 33 AS SHOWN

